

VA FORM 08-6231, OCT 1978

### **GENERAL NOTES:**


- G1. PHOTOGRAPHS ARE SHOWN FOR INFORMATION PURPOSES ONLY REGARDING THE STYLE OF THE FIXTURE.
- G2. REFER TO LIGHTING FIXTURE SCHEDULE E0-2 AND SPECIFICATIONS FOR ADDITIONAL INFORMATION.


**FULLY SPRINKLERED** 


Drawing Title Project Title Project Number **CONSULTANTS: ARCHITECT:** 541-CSI-102 FIXTURE APPEARANCE SCI OUTPATIENT CLINIC Office of GUIDE **ADDITION** Building Number **Facilities** 1100 West 9th Street Cleveland, OH 44113-1003 216-875-0100/ (F) 216-875-0111 barberhoffman.com

BARBER & HOFFMAN, INC.


Consulting Engineers FREDRICK, FREDRICK & HELLER ENGINEERS, INC. DESIGN AND CONSTRUCTION DOCUMENTS AS INSTRUMENTS OF SERVICE ARE GIVEN IN CONFIDENCE AND REMAIN THE PROPERTY OF PERSPECTUS ARCHITECTURE. THE USE OF THIS DESIGN AND THESE CONSTRUCTION DOCUMENTS FOR PURPOSES OTHER THAN THE SPECIFIC PROJECT NAMED HEREIN IS STRICTLY PROHIBITED WITHOUT THE EXPRESSED WRITTEN CONSENT OF PERSPECTUS ARCHITECTURE. COPYRIGHT © 2004. Management Drawing Number Approved: \_ocation 672 EAST ROYALTON ROAD BROADVIEW HTS., OHIO 44147 TEL. (440) 546-9696 **VAMC - WADE PARK** 1-E0.3 FAX: (440) 546-9699 Checked 13212 Shaker Square Suite 204 Cleveland, Ohio 44120 P. 216.752.1800 F. 216.752.3833 Department of Veterans Affairs BID ISSUE 02/23/15 02/23/15 MPL TWM Dwg. Date Revisions:

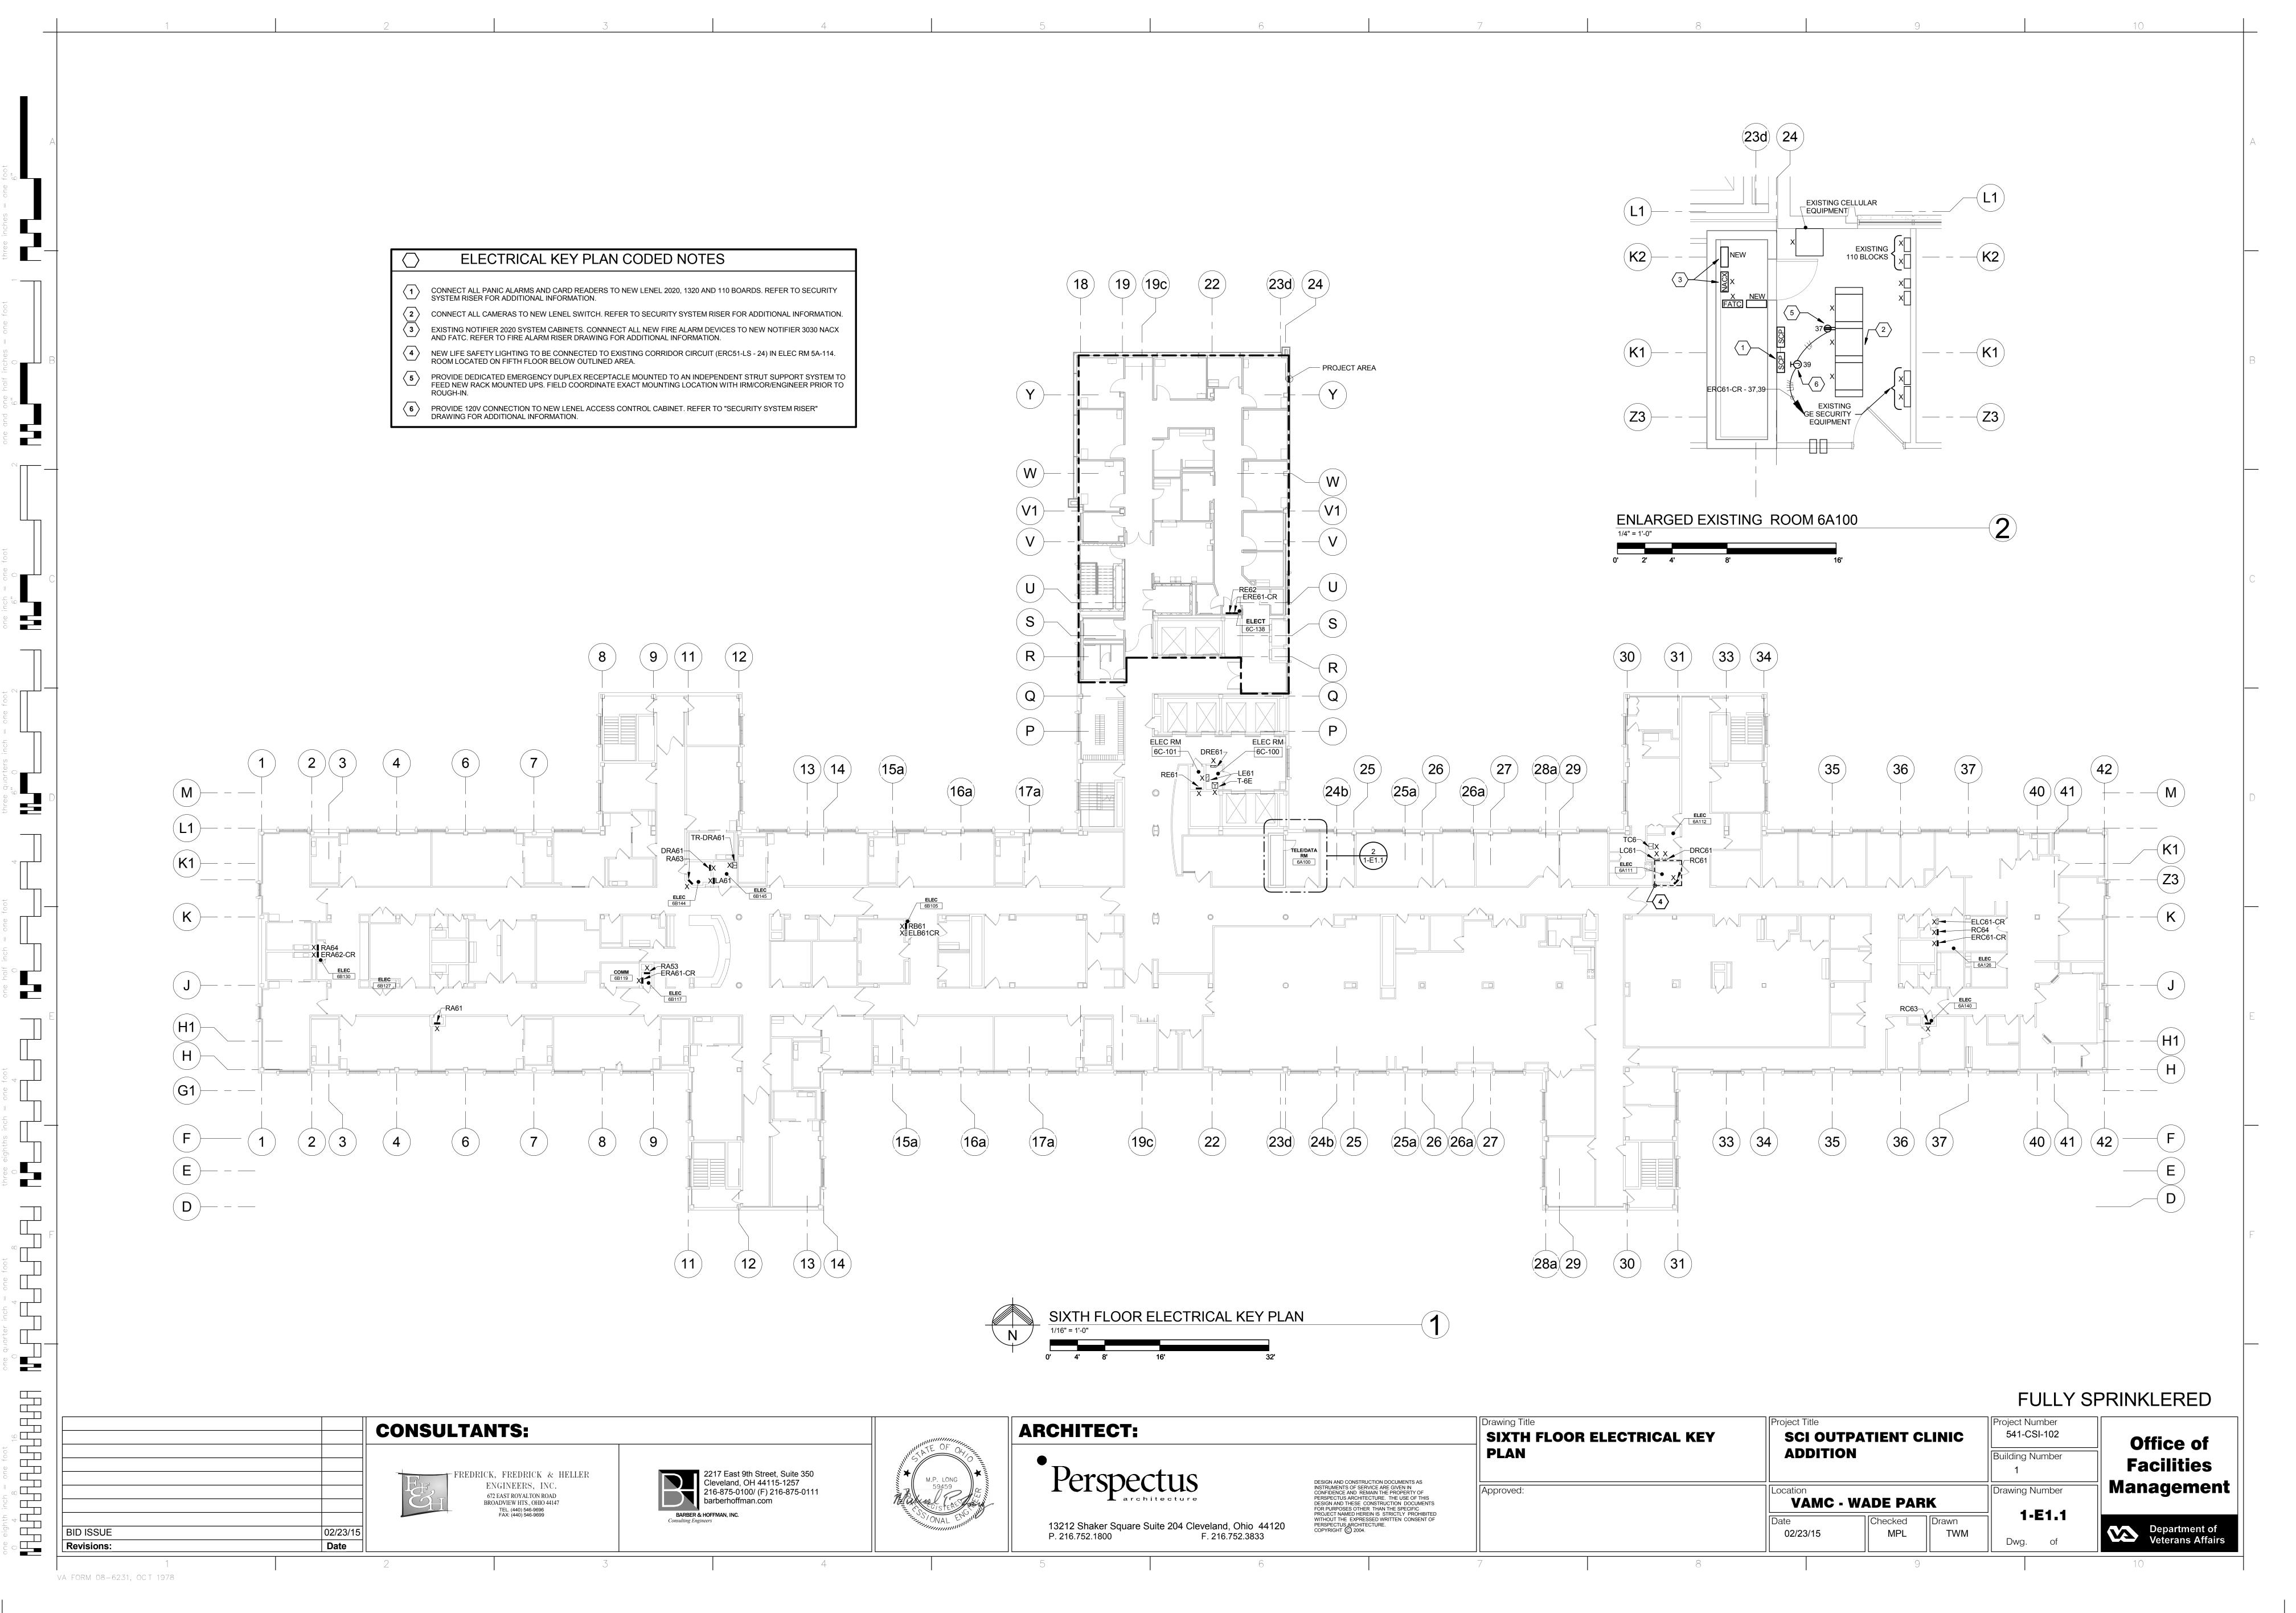

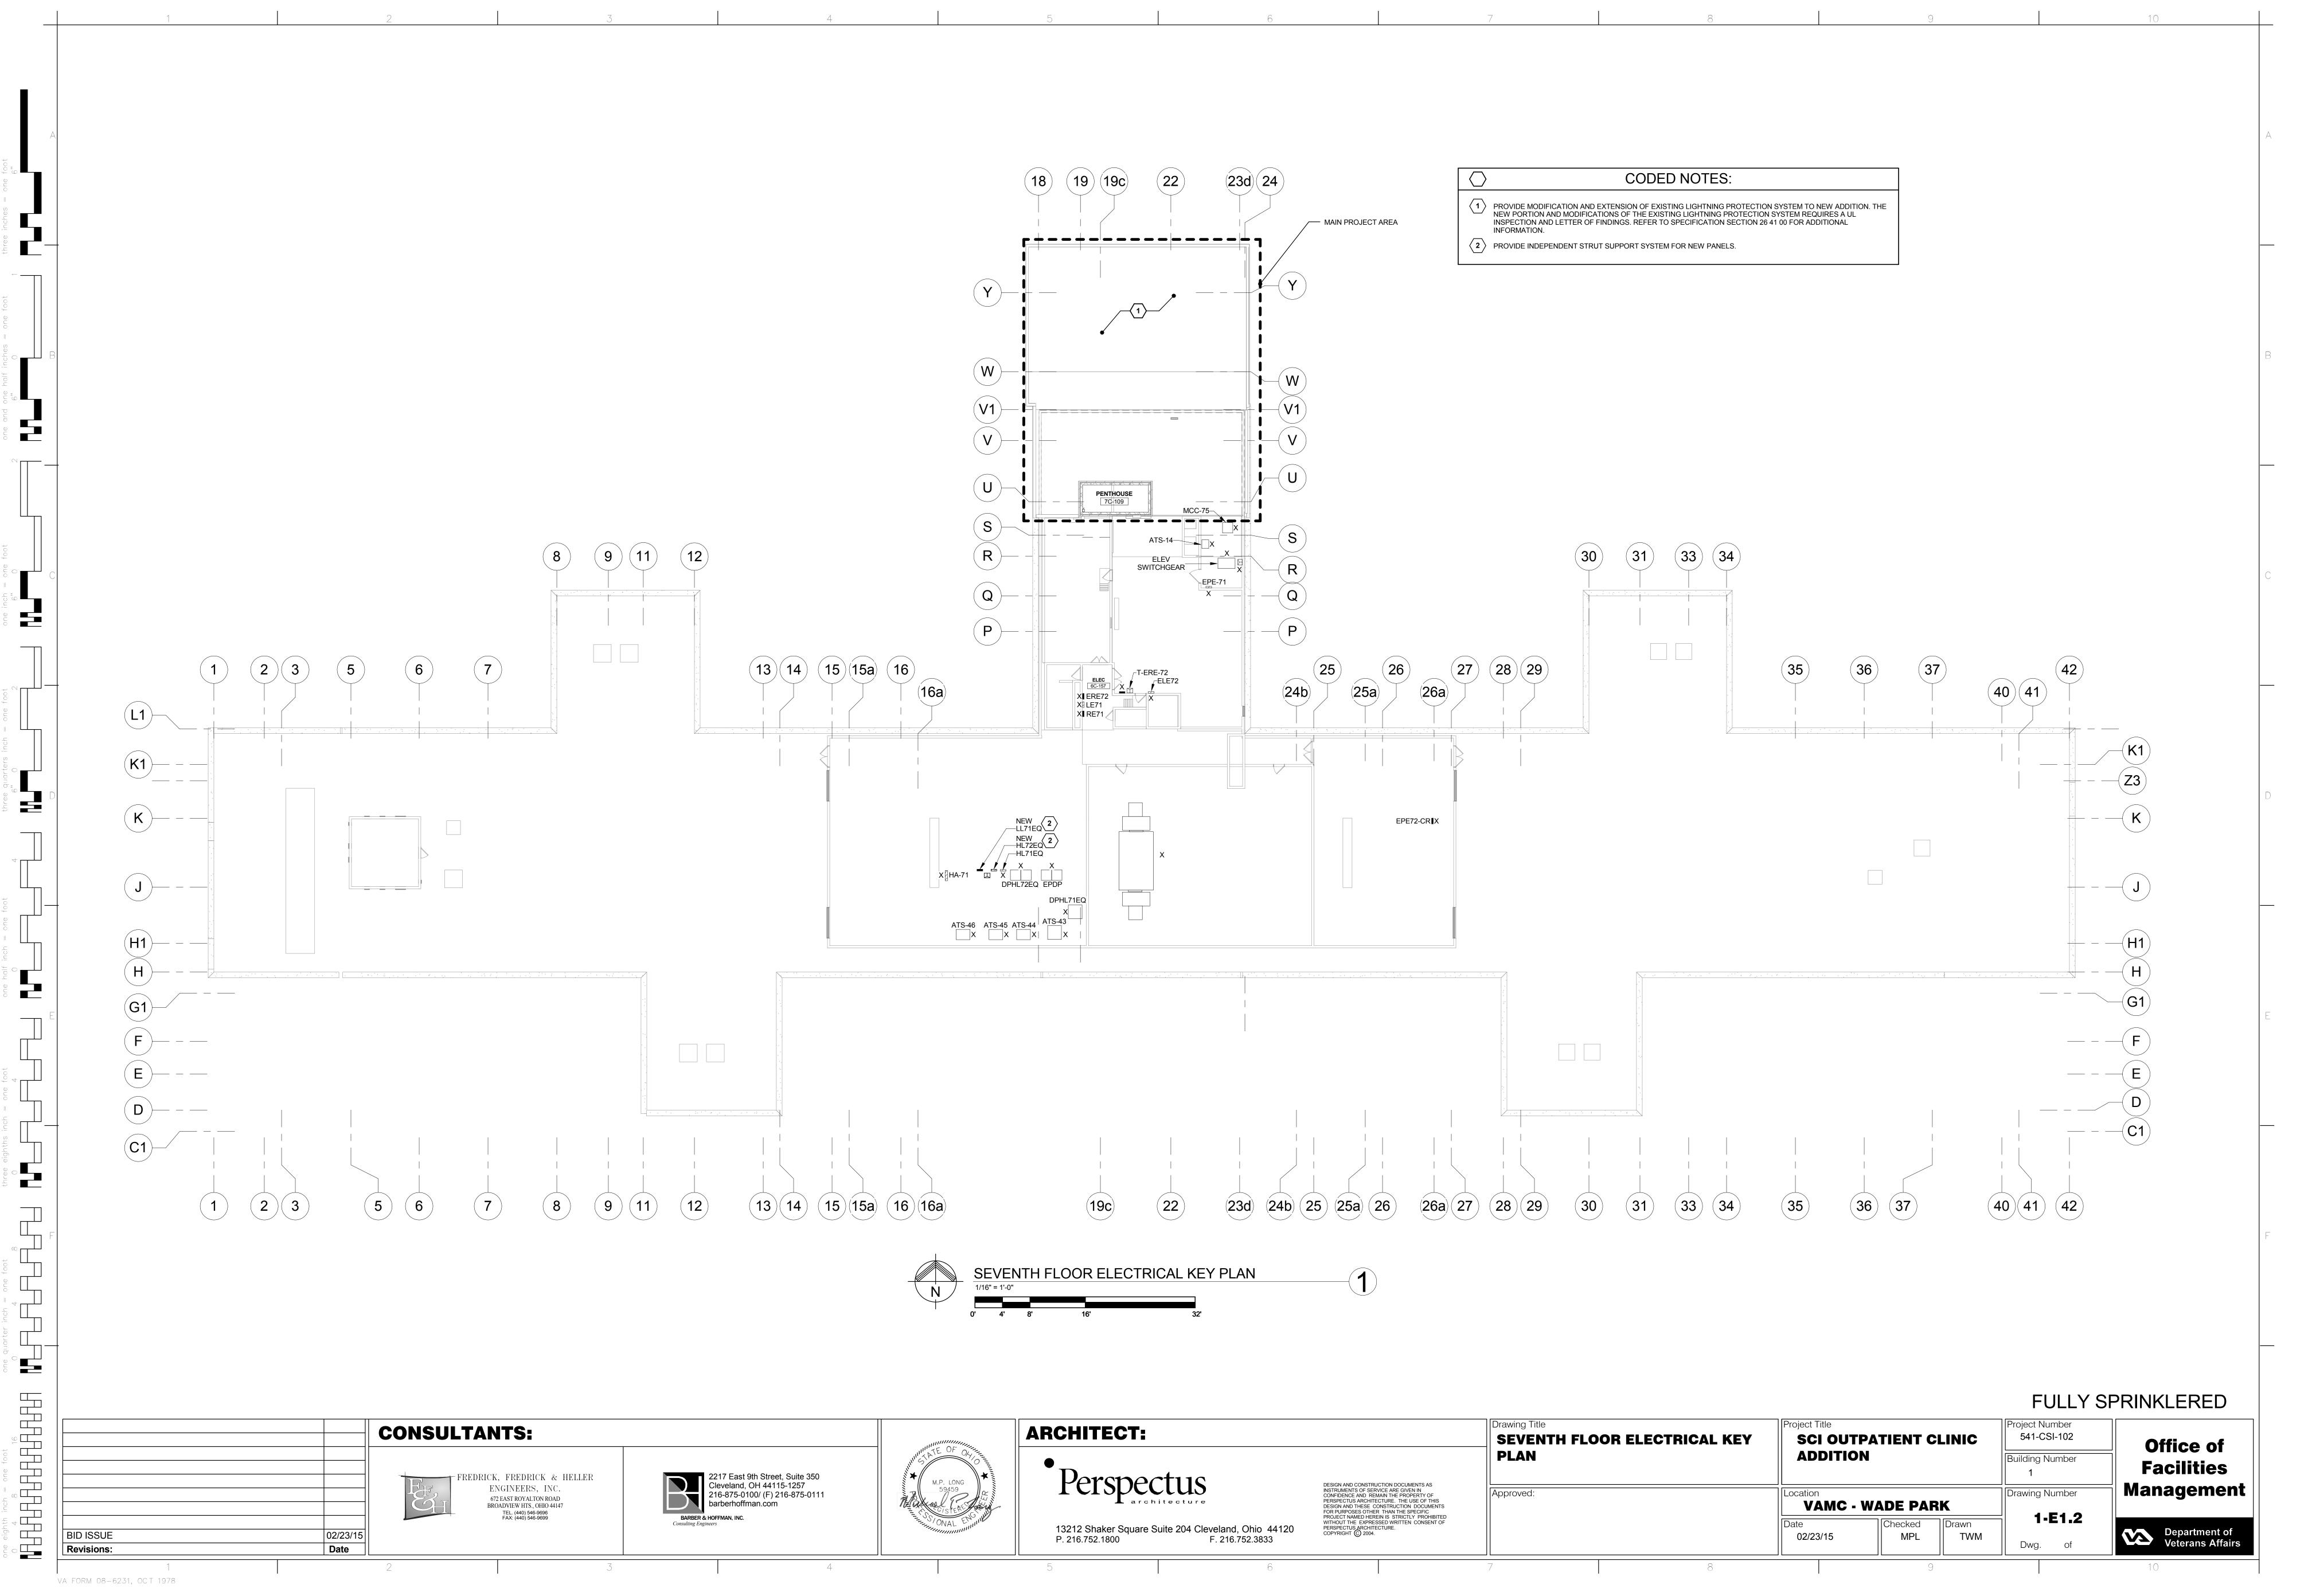

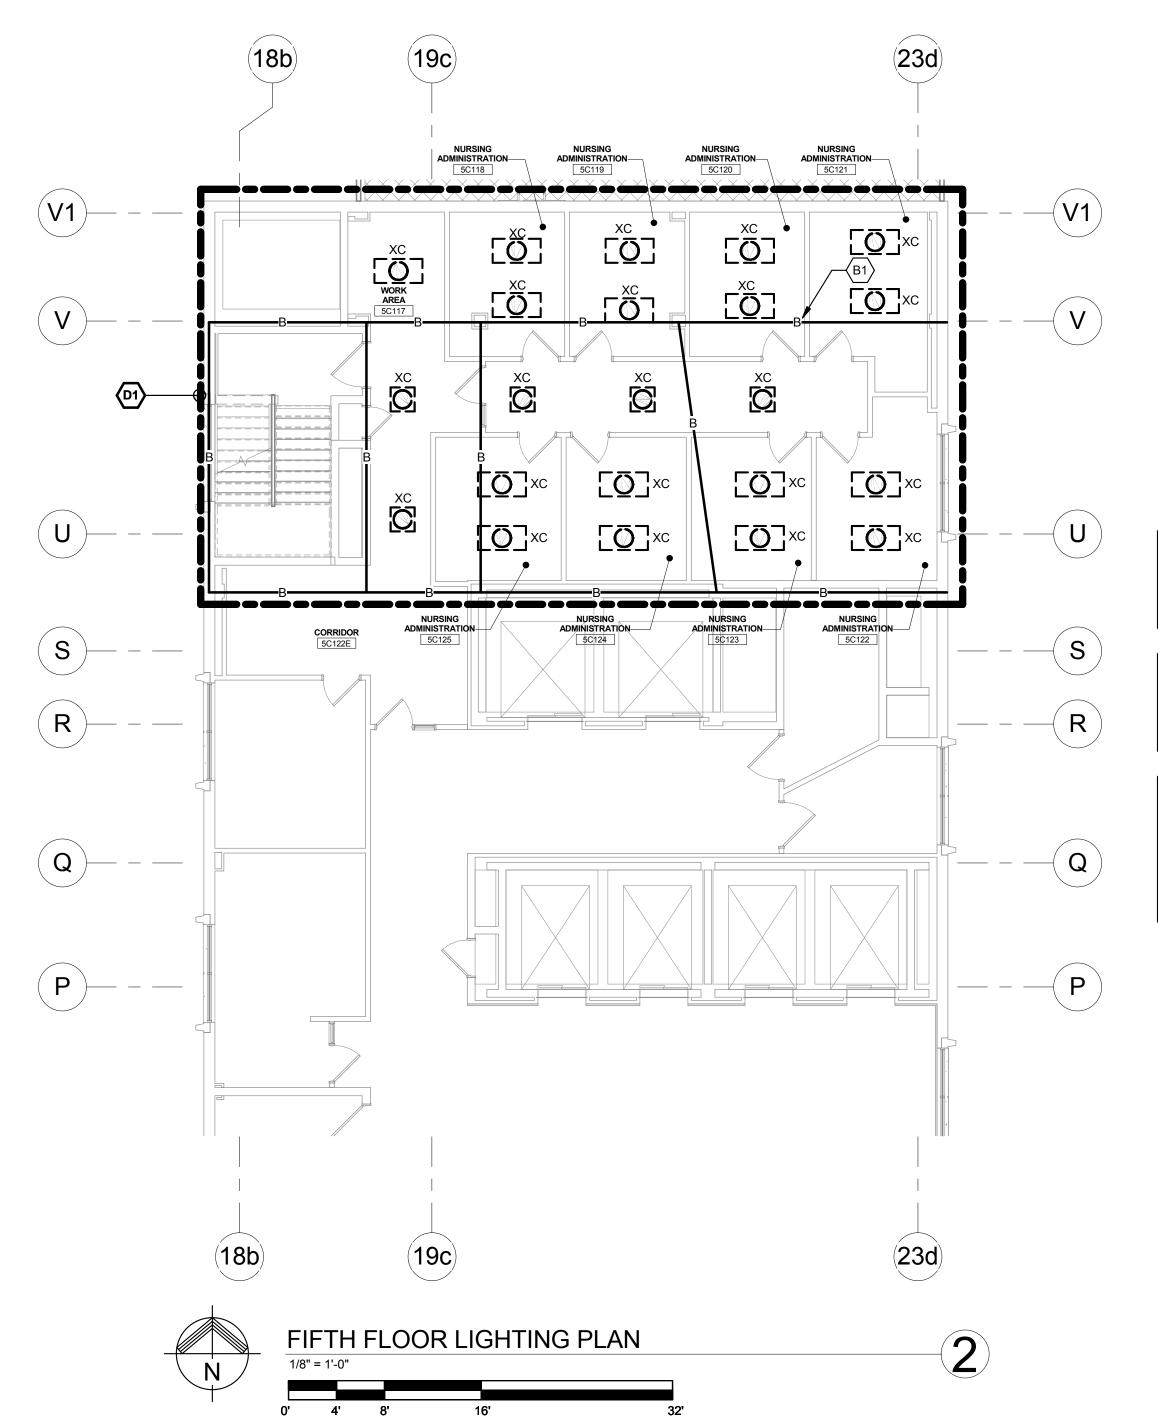


VA FORM 08-6231, OCT 1978

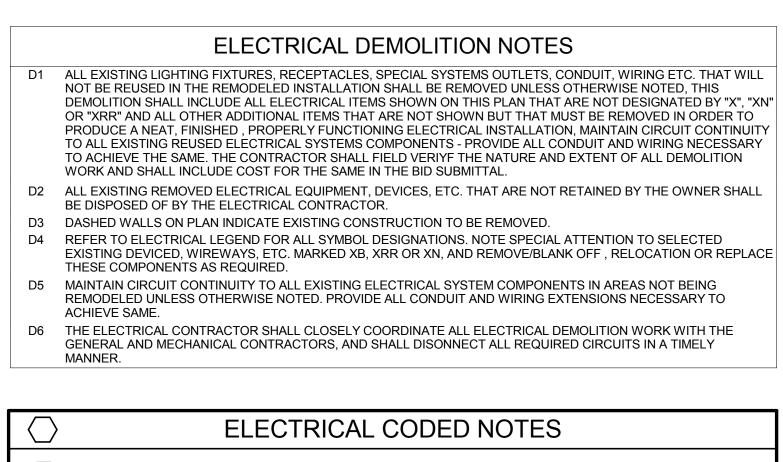

$\bigcirc$	ELECTRICAL CODED NOTES
(A1)	APPROXIMATE LOCATION OF NEW STRUCTURAL BEAMS AND REINFORCEMENTS. RELOCATE 100FT OF 3/4" POWER CONDUIT AND WIRING.


$\bigcirc$	FIRE ALARM & SECURITY CODED NOTES
(B1)	APPROXIMATE LOCATION OF NEW STRUCTURAL BEAMS AND REINFORCEMENTS. RELOCATE 100FT OF 3/4" POWER CONDUIT AND WIRING.

$\bigcirc$	DEDUCT ALTERNATE 2
	UPON THE ACCEPTANCE OF DEDUCT ALTERNATE 2:
(D1)	DELETE THE WORK ASSOCIATED WITH REINSTALLING CEILING MOUNTED DEVICES INCLUDING LIGHTING FIXTURES, SMOKE DETECTORS, WIRELESS ACCESS POINTS, PAGING SPEAKERS, ETC. FOLLOWING COMPLETION OF STRUCTURAL WORK.

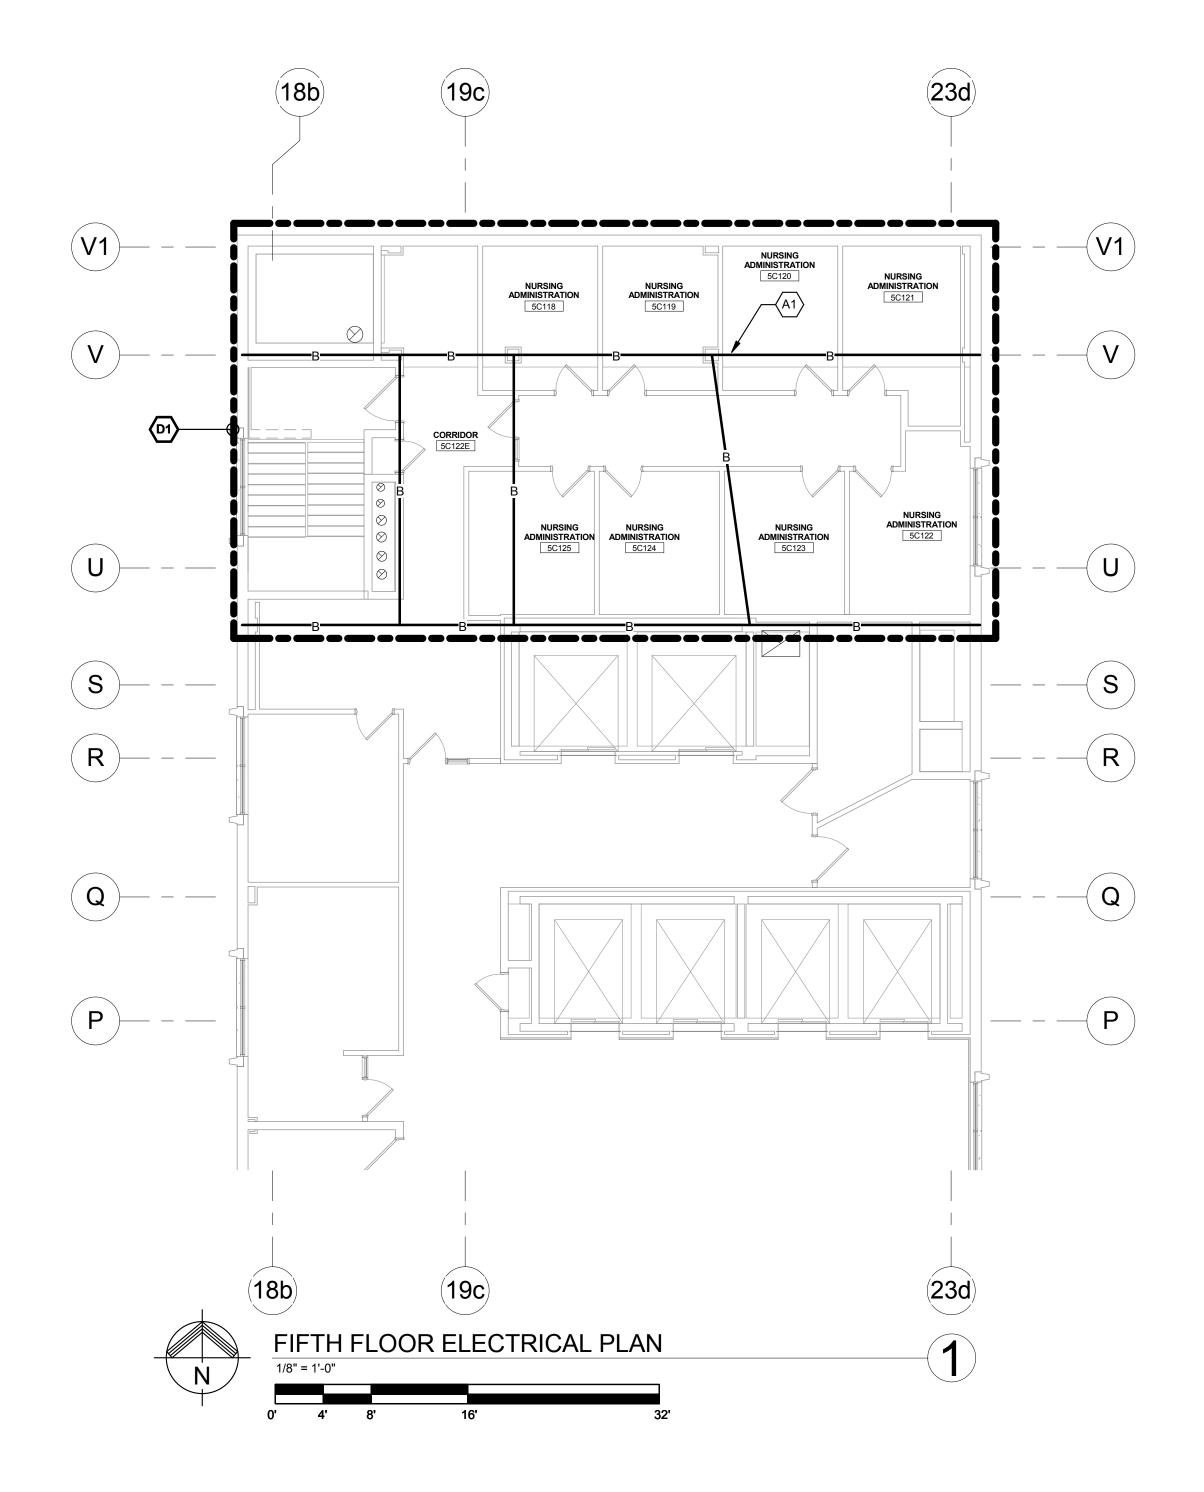

**FULLY SPRINKLERED** 

Drawing Title Project Title Project Number **ARCHITECT: CONSULTANTS:** 541-CSI-102 FIFTH FLOOR ELECTRICAL, FIRE SCI OUTPATIENT CLINIC Office of ALARM AND SECURITY PLAN **ADDITION** Building Number **Facilities** 2217 East 9th Street, Suite 350 Cleveland, OH 44115-1257 216-875-0100/ (F) 216-875-0111 FREDRICK, FREDRICK & HELLER DESIGN AND CONSTRUCTION DOCUMENTS AS INSTRUMENTS OF SERVICE ARE GIVEN IN CONFIDENCE AND REMAIN THE PROPERTY OF PERSPECTUS ARCHITECTURE. THE USE OF THIS DESIGN AND THESE CONSTRUCTION DOCUMENTS FOR PURPOSES OTHER THAN THE SPECIFIC PROJECT NAMED HEREIN IS STRICTLY PROHIBITED WITHOUT THE EXPRESSED WRITTEN CONSENT OF PERSPECTUS ARCHITECTURE. COPYRIGHT © 2004. Management ENGINEERS, INC. Drawing Number Approved: 672 EAST ROYALTON ROAD VAMC - WADE PARK barberhoffman.com BROADVIEW HTS., OHIO 44147 TEL. (440) 546-9696 FAX: (440) 546-9699 1-E2.1 BARBER & HOFFMAN, INC. Drawn Checked 13212 Shaker Square Suite 204 Cleveland, Ohio 44120 Department of Veterans Affairs BID ISSUE 02/23/15 02/23/15 TWM MPL P. 216.752.1800 F. 216.752.3833 Dwg. Date **Revisions:** 

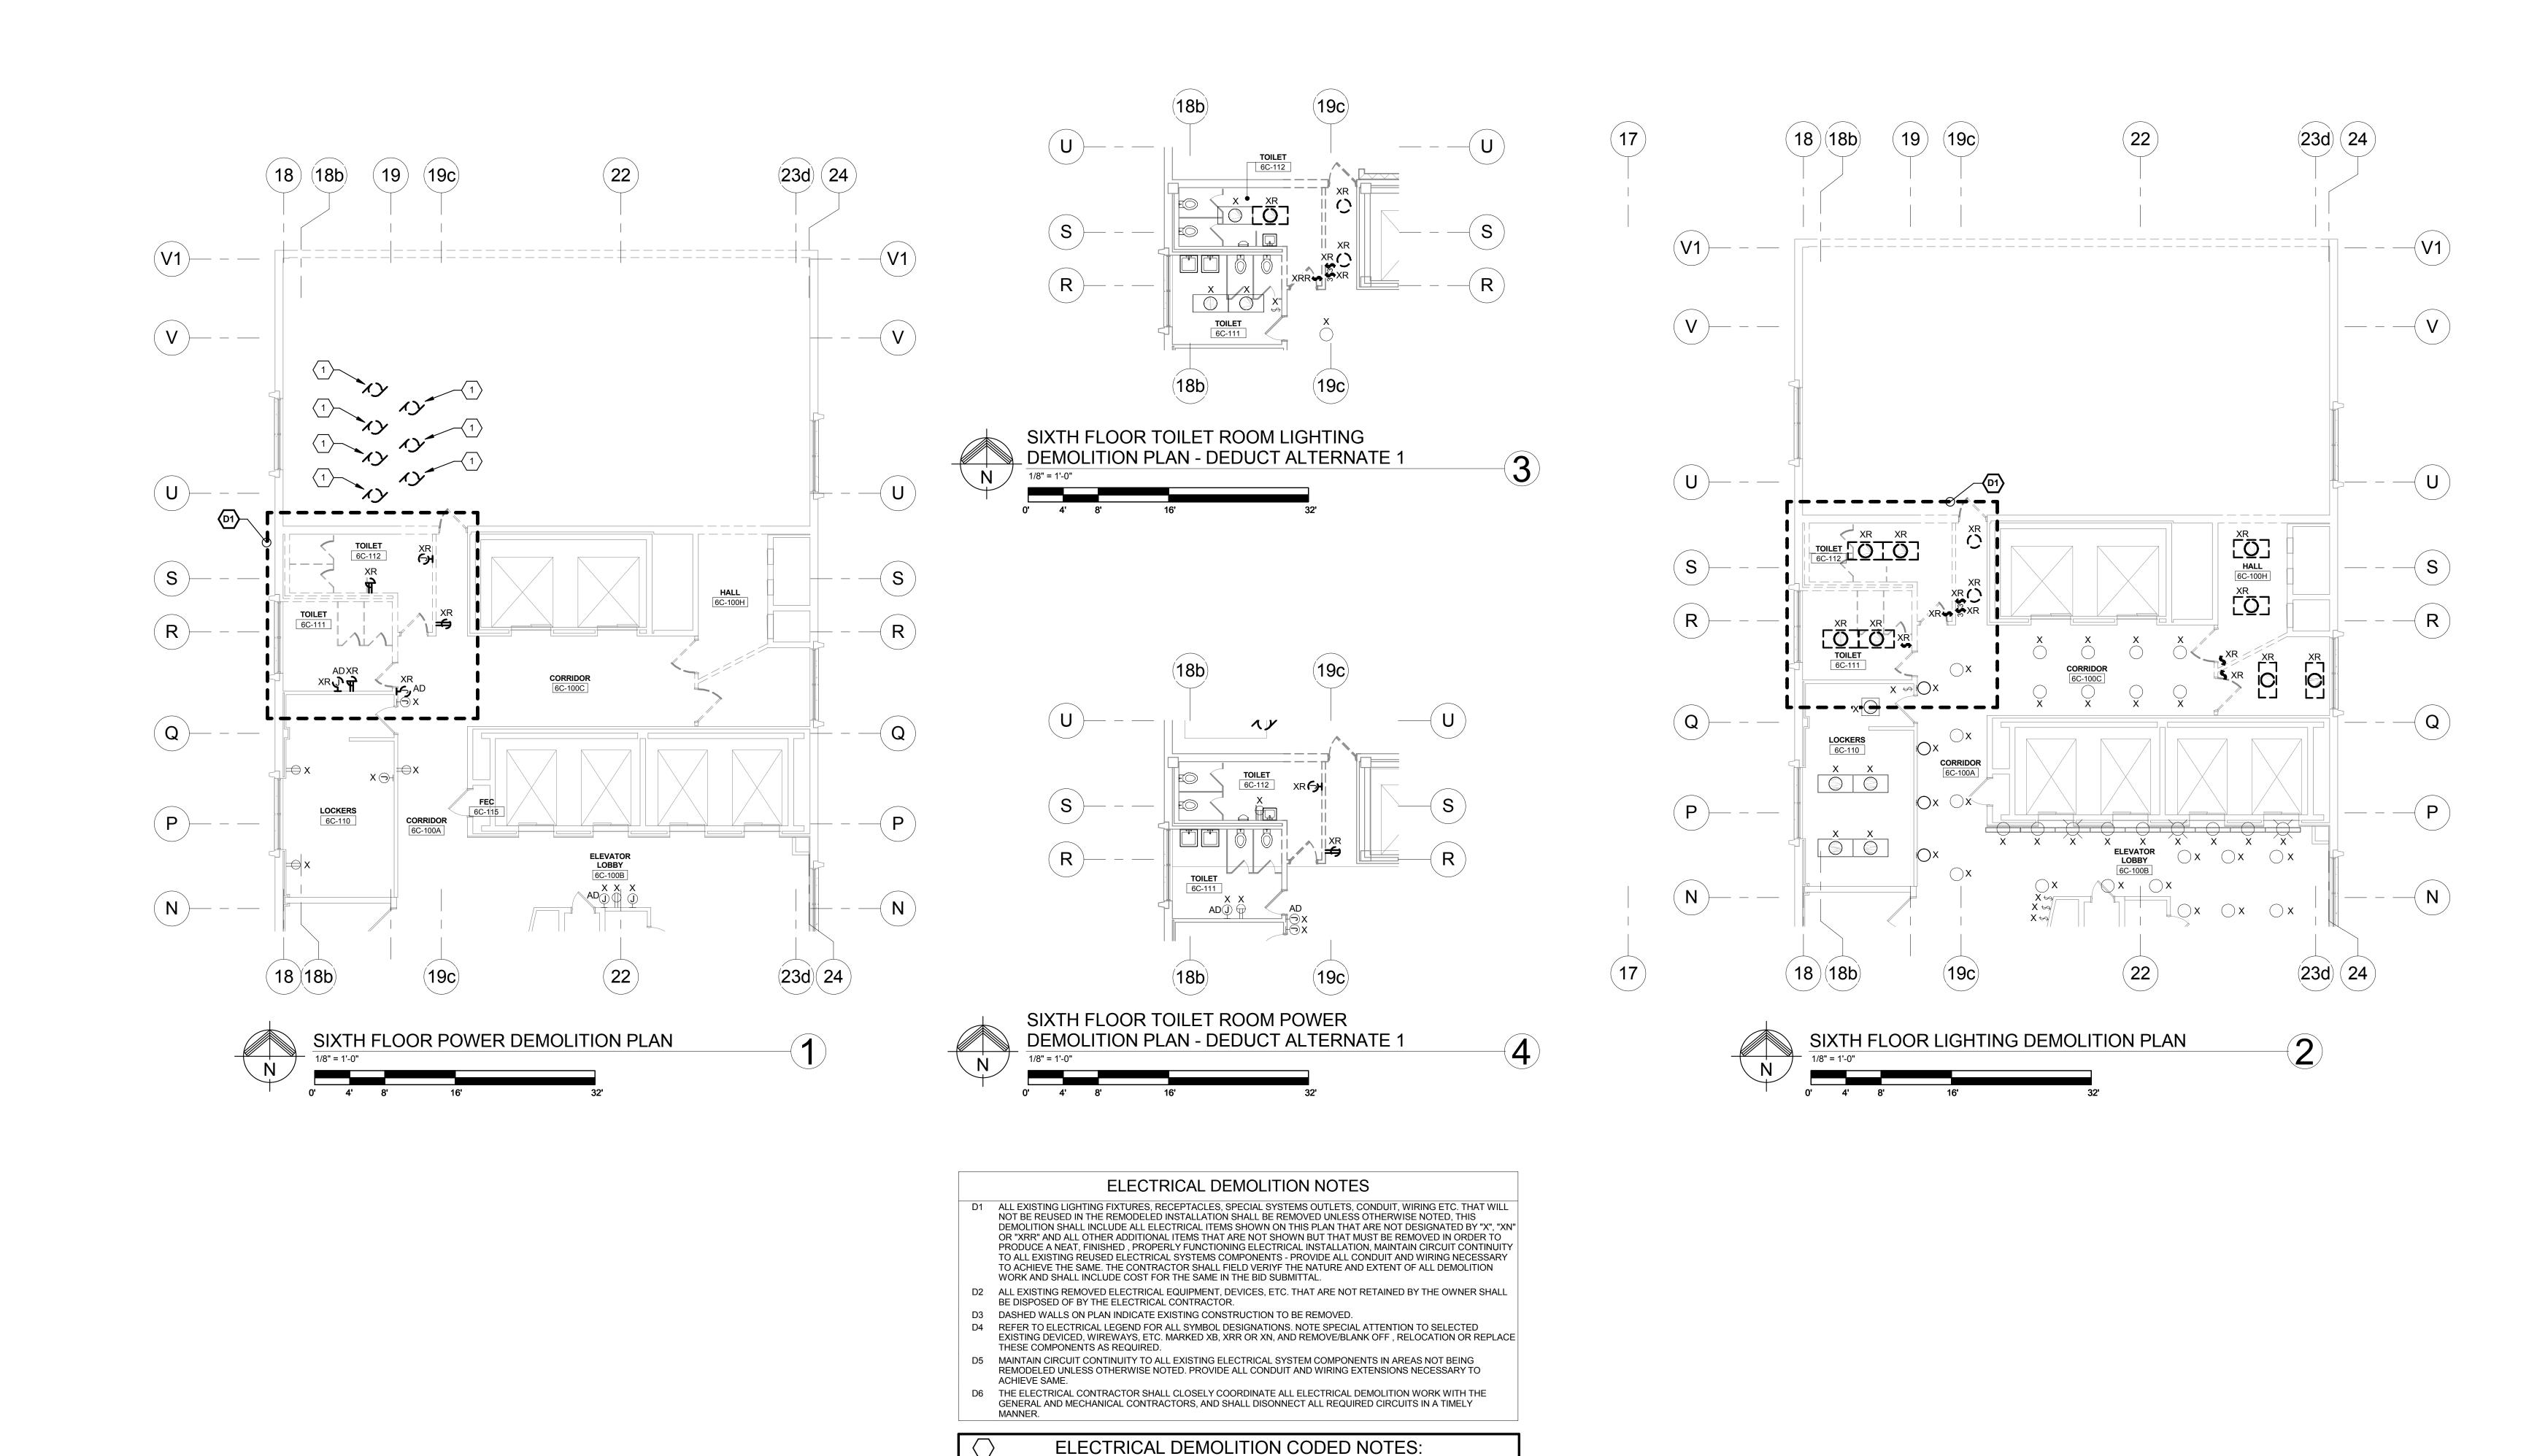

#### **FULLY SPRINKLERED** Drawing Title Project Title Project Number **ARCHITECT: CONSULTANTS:** 541-CSI-102 SIXTH FLOOR ELECTRICAL SCI OUTPATIENT CLINIC Office of **DEMOLITION PLAN ADDITION** Building Number **Facilities** 2217 East 9th Street, Suite 350 Cleveland, OH 44115-1257 FREDRICK, FREDRICK & HELLER DESIGN AND CONSTRUCTION DOCUMENTS AS INSTRUMENTS OF SERVICE ARE GIVEN IN CONFIDENCE AND REMAIN THE PROPERTY OF PERSPECTUS ARCHITECTURE. THE USE OF THIS DESIGN AND THESE CONSTRUCTION DOCUMENTS FOR PURPOSES OTHER THAN THE SPECIFIC PROJECT NAMED HEREIN IS STRICTLY PROHIBITED WITHOUT THE EXPRESSED WRITTEN CONSENT OF PERSPECTUS ARCHITECTURE. COPYRIGHT © 2004. Management ENGINEERS, INC. Drawing Number 216-875-0100/ (F) 216-875-0111 Approved: 672 EAST ROYALTON ROAD **VAMC - WADE PARK** barberhoffman.com BROADVIEW HTS., OHIO 44147 TEL. (440) 546-9696 FAX: (440) 546-9699 1-E2.2 BARBER & HOFFMAN, INC. Checked Drawn 13212 Shaker Square Suite 204 Cleveland, Ohio 44120 Department of Veterans Affairs

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Dwg.

MPL

02/23/15

(1) DISCONNECT EXISTING LAB EXHAUST FANS AND REMOVE CONDUIT, WIRING, AND ALL ASSOCIATED ELECTRICAL EQUIPMENT COMPLETE BACK TO MCC-75 LOCATED IN PENTHOUSE ELEVATOR

(D1) COMPLETE WORK AS SHOWN IN "DEDUCT ALTERNATE 1" PLANS ON THIS DRAWING IN LIEU OF WORK IN

**DEDUCT ALTERNATE 1** 

SWITCHGEAR ROOM. REFER TO 1-E3.3 FOR LOCATION OF MCC-75.

P. 216.752.1800

UPON THE ACCEPTANCE OF DEDUCT ALTERNATE 1:

OUTLINED AREA


8 4 9 VA FORM 08-6231, OCT 1978

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Revisions:

02/23/15

Date

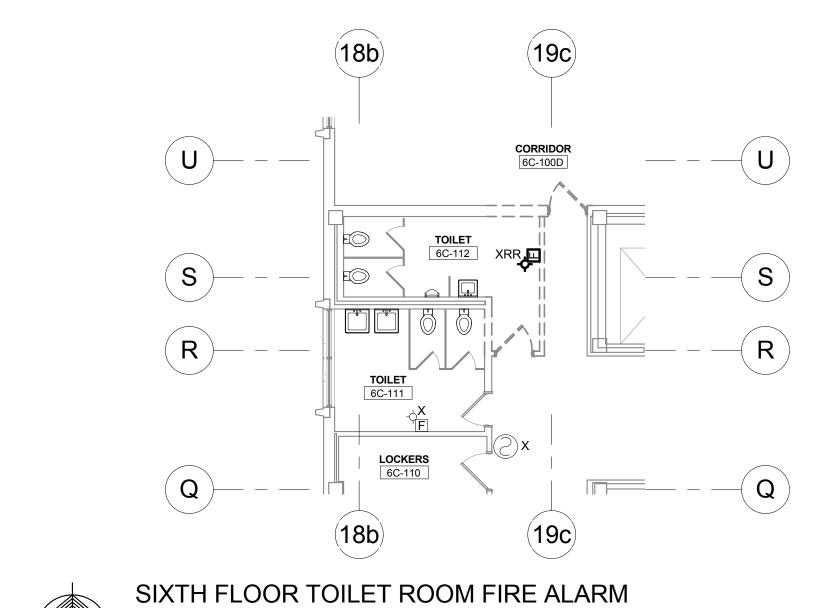

### ELECTRICAL DEMOLITION NOTES

**DEMOLITION PLAN - DEDUCT ALTERNATE 1** 

- D1 ALL EXISTING LIGHTING FIXTURES, RECEPTACLES, SPECIAL SYSTEMS OUTLETS, CONDUIT, WIRING ETC. THAT WILL NOT BE REUSED IN THE REMODELED INSTALLATION SHALL BE REMOVED UNLESS OTHERWISE NOTED, THIS DEMOLITION SHALL INCLUDE ALL ELECTRICAL ITEMS SHOWN ON THIS PLAN THAT ARE NOT DESIGNATED BY "X", "XN" OR "XRR" AND ALL OTHER ADDITIONAL ITEMS THAT ARE NOT SHOWN BUT THAT MUST BE REMOVED IN ORDER TO PRODUCE A NEAT, FINISHED, PROPERLY FUNCTIONING ELECTRICAL INSTALLATION, MAINTAIN CIRCUIT CONTINUITY TO ALL EXISTING REUSED ELECTRICAL SYSTEMS COMPONENTS PROVIDE ALL CONDUIT AND WIRING NECESSARY TO ACHIEVE THE SAME. THE CONTRACTOR SHALL FIELD VERIFY THE NATURE AND EXTENT OF ALL DEMOLITION
- WORK AND SHALL INCLUDE COST FOR THE SAME IN THE BID SUBMITTAL.

  D2 ALL EXISTING REMOVED ELECTRICAL EQUIPMENT, DEVICES, ETC. THAT ARE NOT RETAINED BY THE OWNER SHALL BE DISPOSED OF BY THE ELECTRICAL CONTRACTOR.


  D3 DASHED WALLS ON PLAN INDICATE EXISTING CONSTRUCTION TO BE REMOVED.
- REFER TO ELECTRICAL LEGEND FOR ALL SYMBOL DESIGNATIONS. NOTE SPECIAL ATTENTION TO SELECTED EXISTING DEVICED, WIREWAYS, ETC. MARKED XB, XRR OR XN, AND REMOVE/BLANK OFF, RELOCATION OR REPLACE THESE COMPONENTS AS REQUIRED.
   MAINTAIN CIRCUIT CONTINUITY TO ALL EXISTING ELECTRICAL SYSTEM COMPONENTS IN AREAS NOT BEING REMODELED UNLESS OTHERWISE NOTED. PROVIDE ALL CONDUIT AND WIRING EXTENSIONS NECESSARY TO
- D6 THE ELECTRICAL CONTRACTOR SHALL CLOSELY COORDINATE ALL ELECTRICAL DEMOLITION WORK WITH THE GENERAL AND MECHANICAL CONTRACTORS, AND SHALL DISONNECT ALL REQUIRED CIRCUITS IN A TIMELY

### DEDUCT ALTERNATE 1

UPON THE ACCEPTANCE OF DEDUCT ALTERNATE 1:


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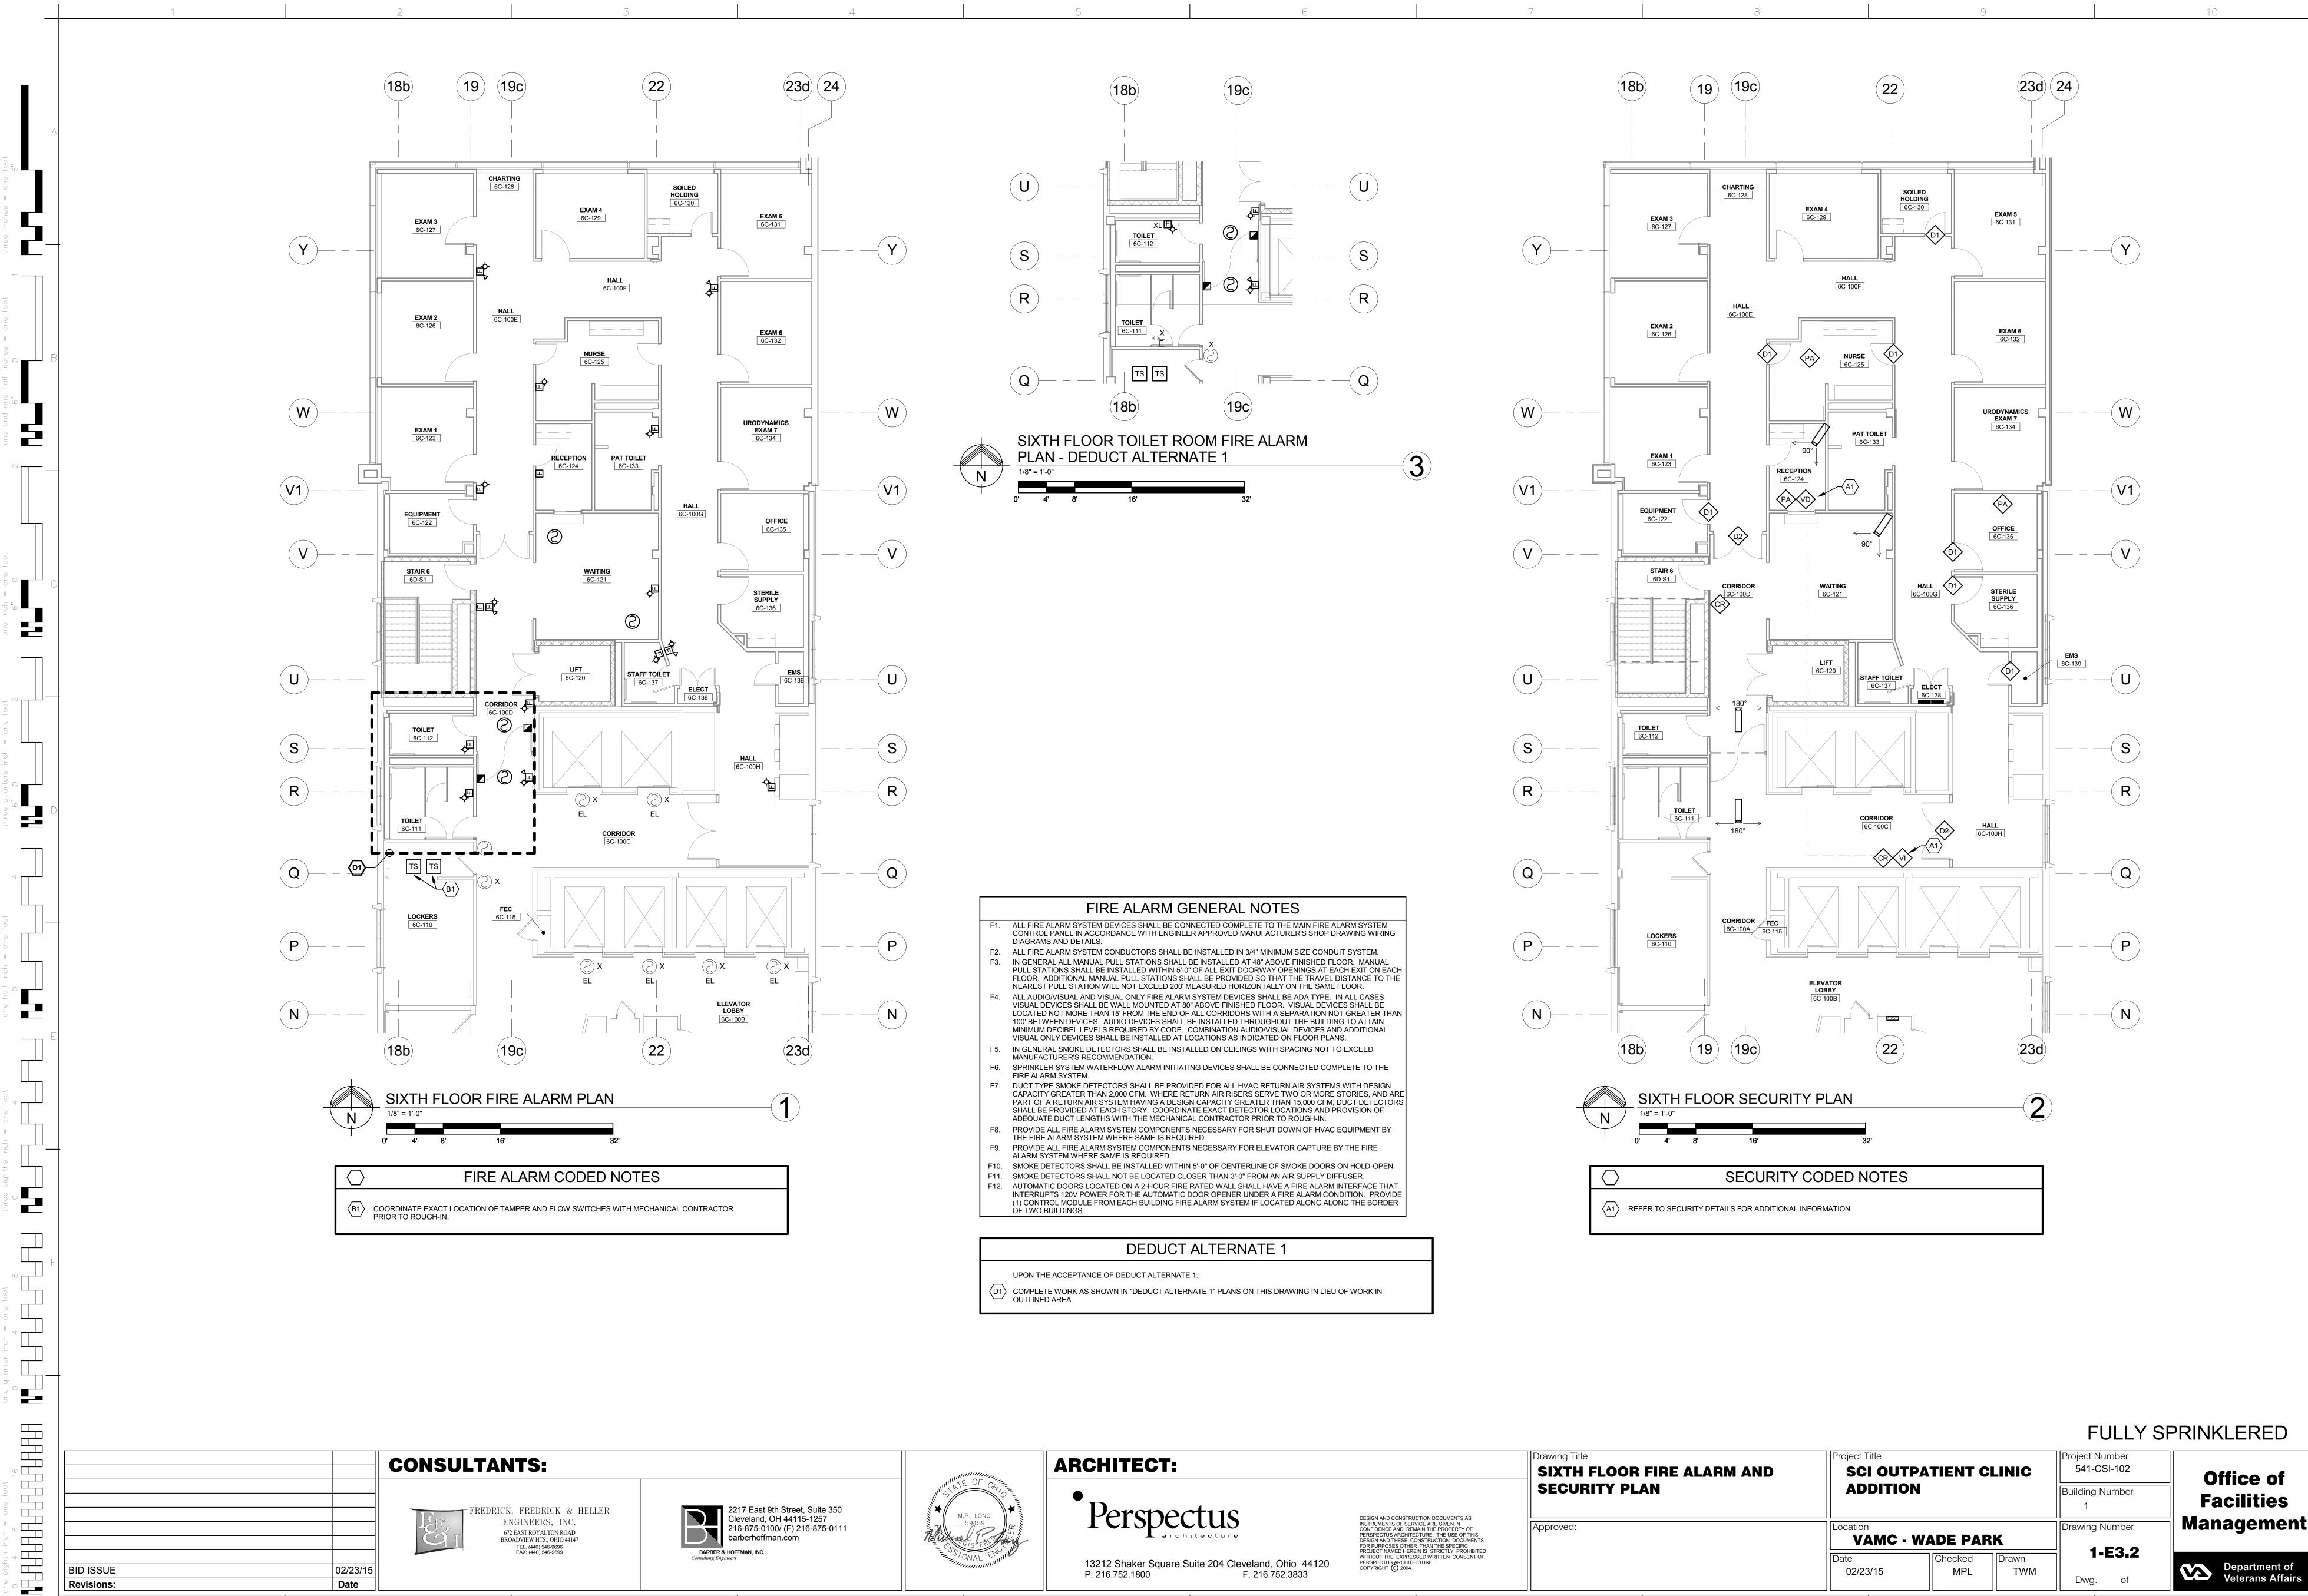
COMPLETE WORK AS SHOWN IN "DEDUCT ALTERNATE 1" PLANS ON THIS DRAWING IN LIEU OF WORK IN OUTLINED AREA

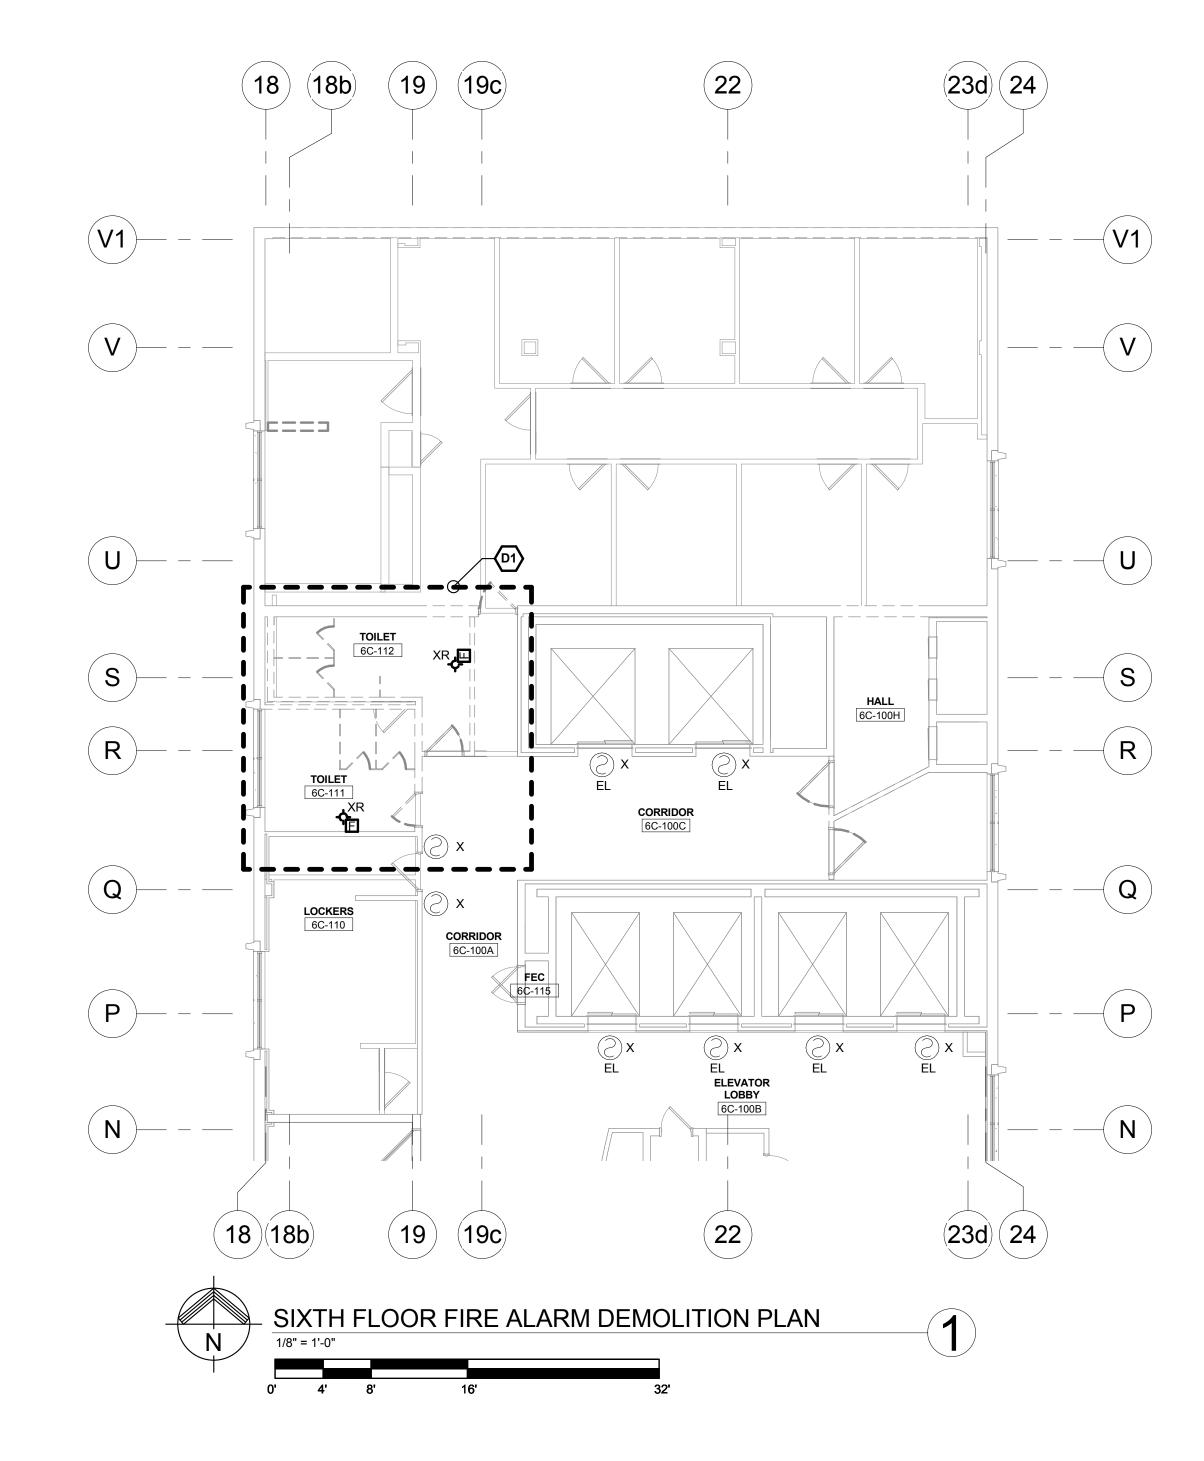

### **FULLY SPRINKLERED**

Drawing Title Project Title Project Number **CONSULTANTS: ARCHITECT:** 541-CSI-102 SCI OUTPATIENT CLINIC SIXTH FLOOR FIRE ALARM AND Office of SECURITY DEMOLITION PLAN **ADDITION** Building Number **Facilities** 2217 East 9th Street, Suite 350 Cleveland, OH 44115-1257 216-875-0100/ (F) 216-875-0111 FREDRICK, FREDRICK & HELLER DESIGN AND CONSTRUCTION DOCUMENTS AS INSTRUMENTS OF SERVICE ARE GIVEN IN CONFIDENCE AND REMAIN THE PROPERTY OF PERSPECTUS ARCHITECTURE. THE USE OF THIS DESIGN AND THESE CONSTRUCTION DOCUMENTS FOR PURPOSES OTHER THAN THE SPECIFIC PROJECT NAMED HEREIN IS STRICTLY PROHIBITED WITHOUT THE EXPRESSED WRITTEN CONSENT OF PERSPECTUS ARCHITECTURE. COPYRIGHT © 2004. Management ENGINEERS, INC. Drawing Number Approved: 672 EAST ROYALTON ROAD **VAMC - WADE PARK** barberhoffman.com BROADVIEW HTS., OHIO 44147 TEL. (440) 546-9696 FAX: (440) 546-9699 1-E2.3 BARBER & HOFFMAN, INC. Drawn Checked 13212 Shaker Square Suite 204 Cleveland, Ohio 44120 Department of Veterans Affairs BID ISSUE 02/23/15 TWM MPL P. 216.752.1800 F. 216.752.3833 Dwg. Date **Revisions:** 



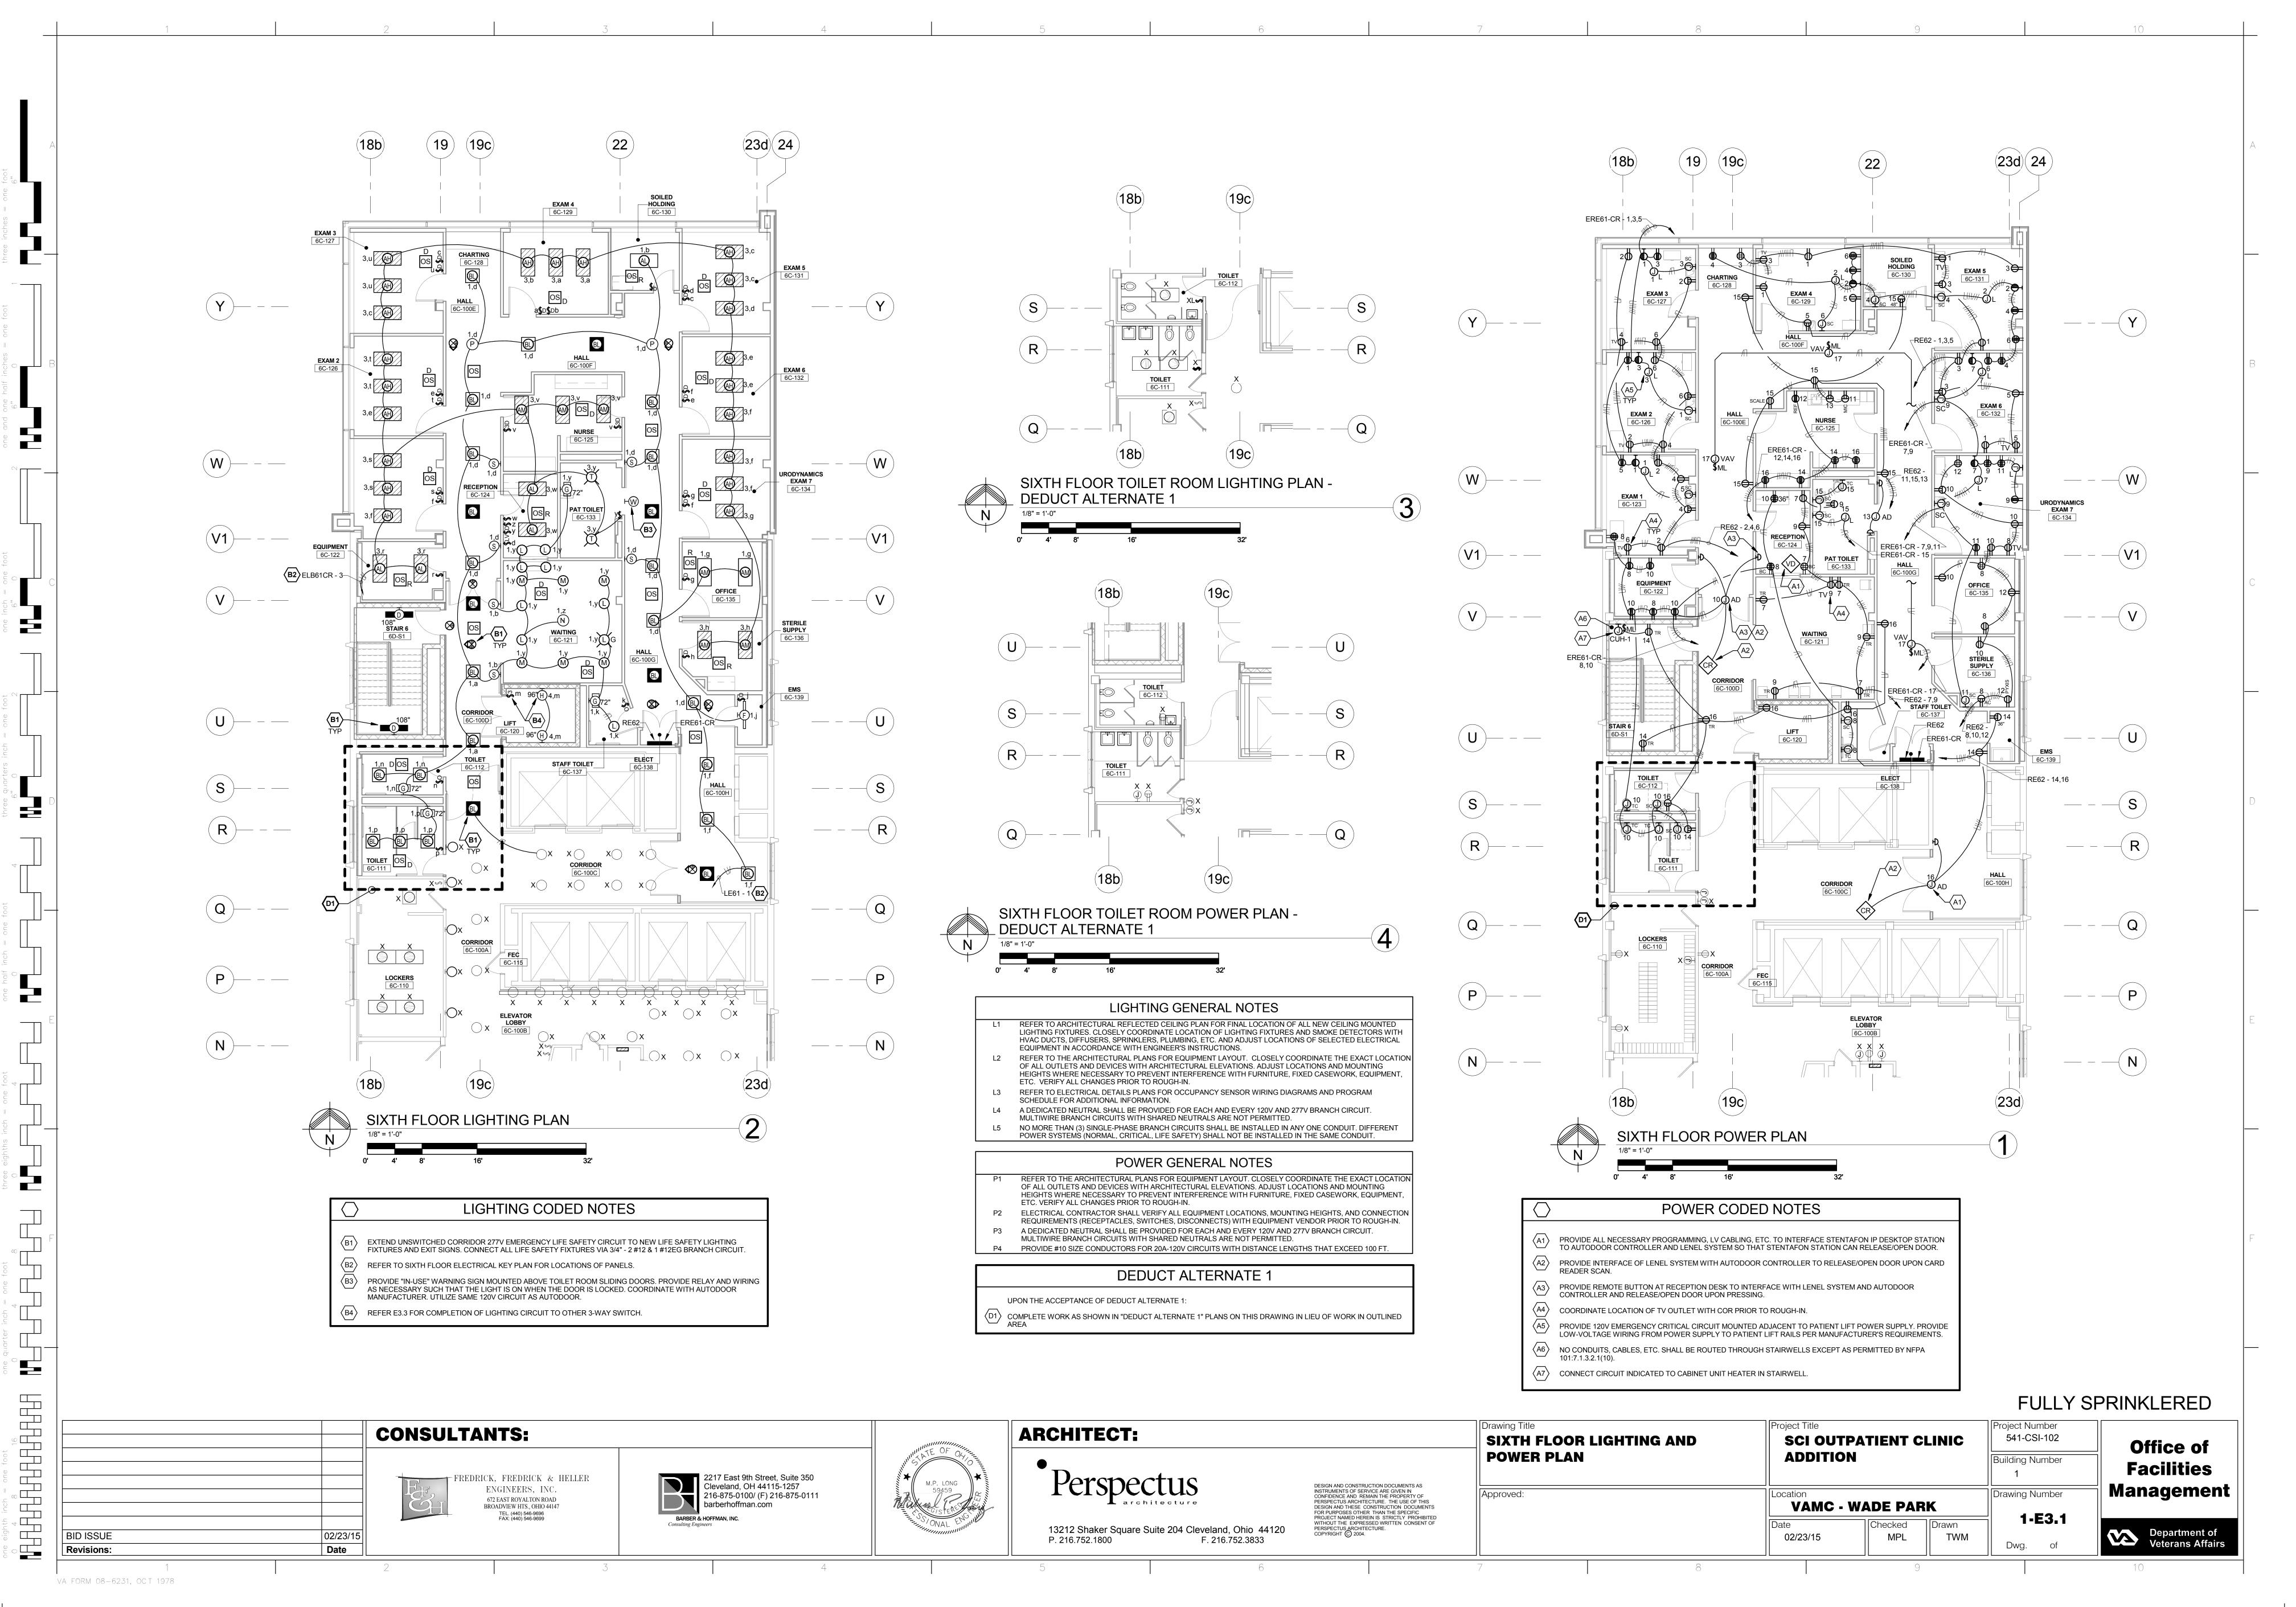

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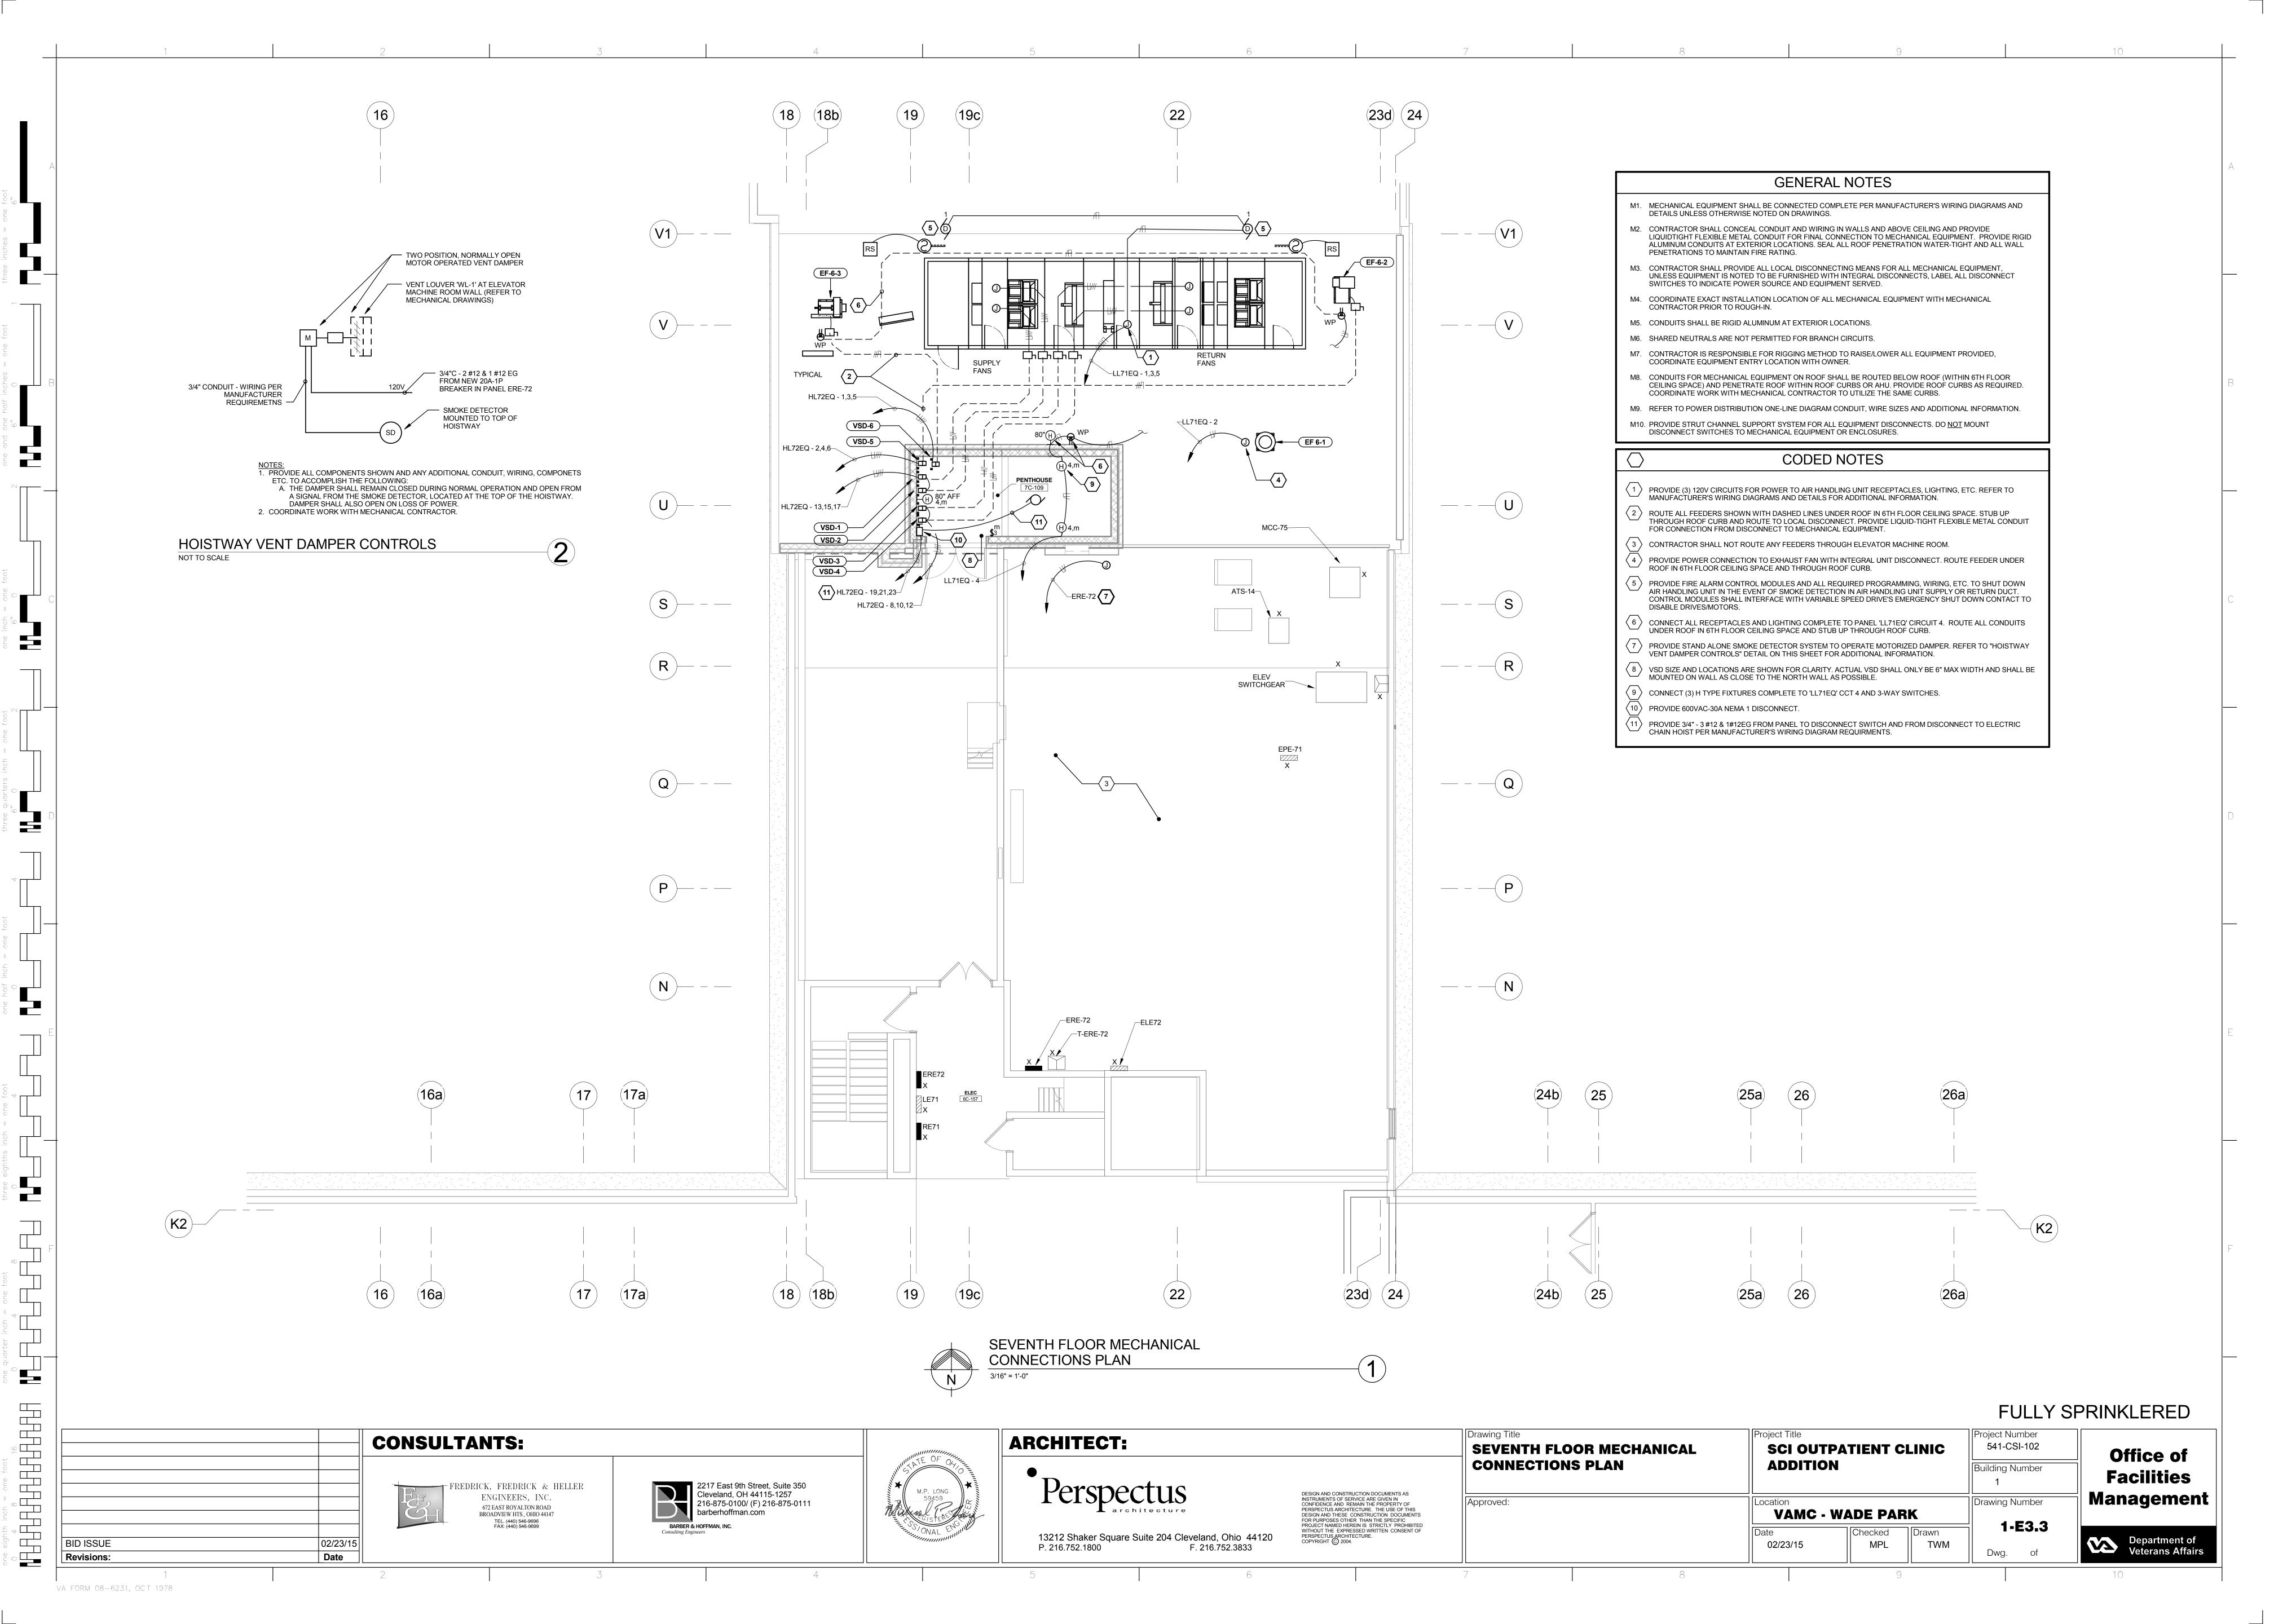
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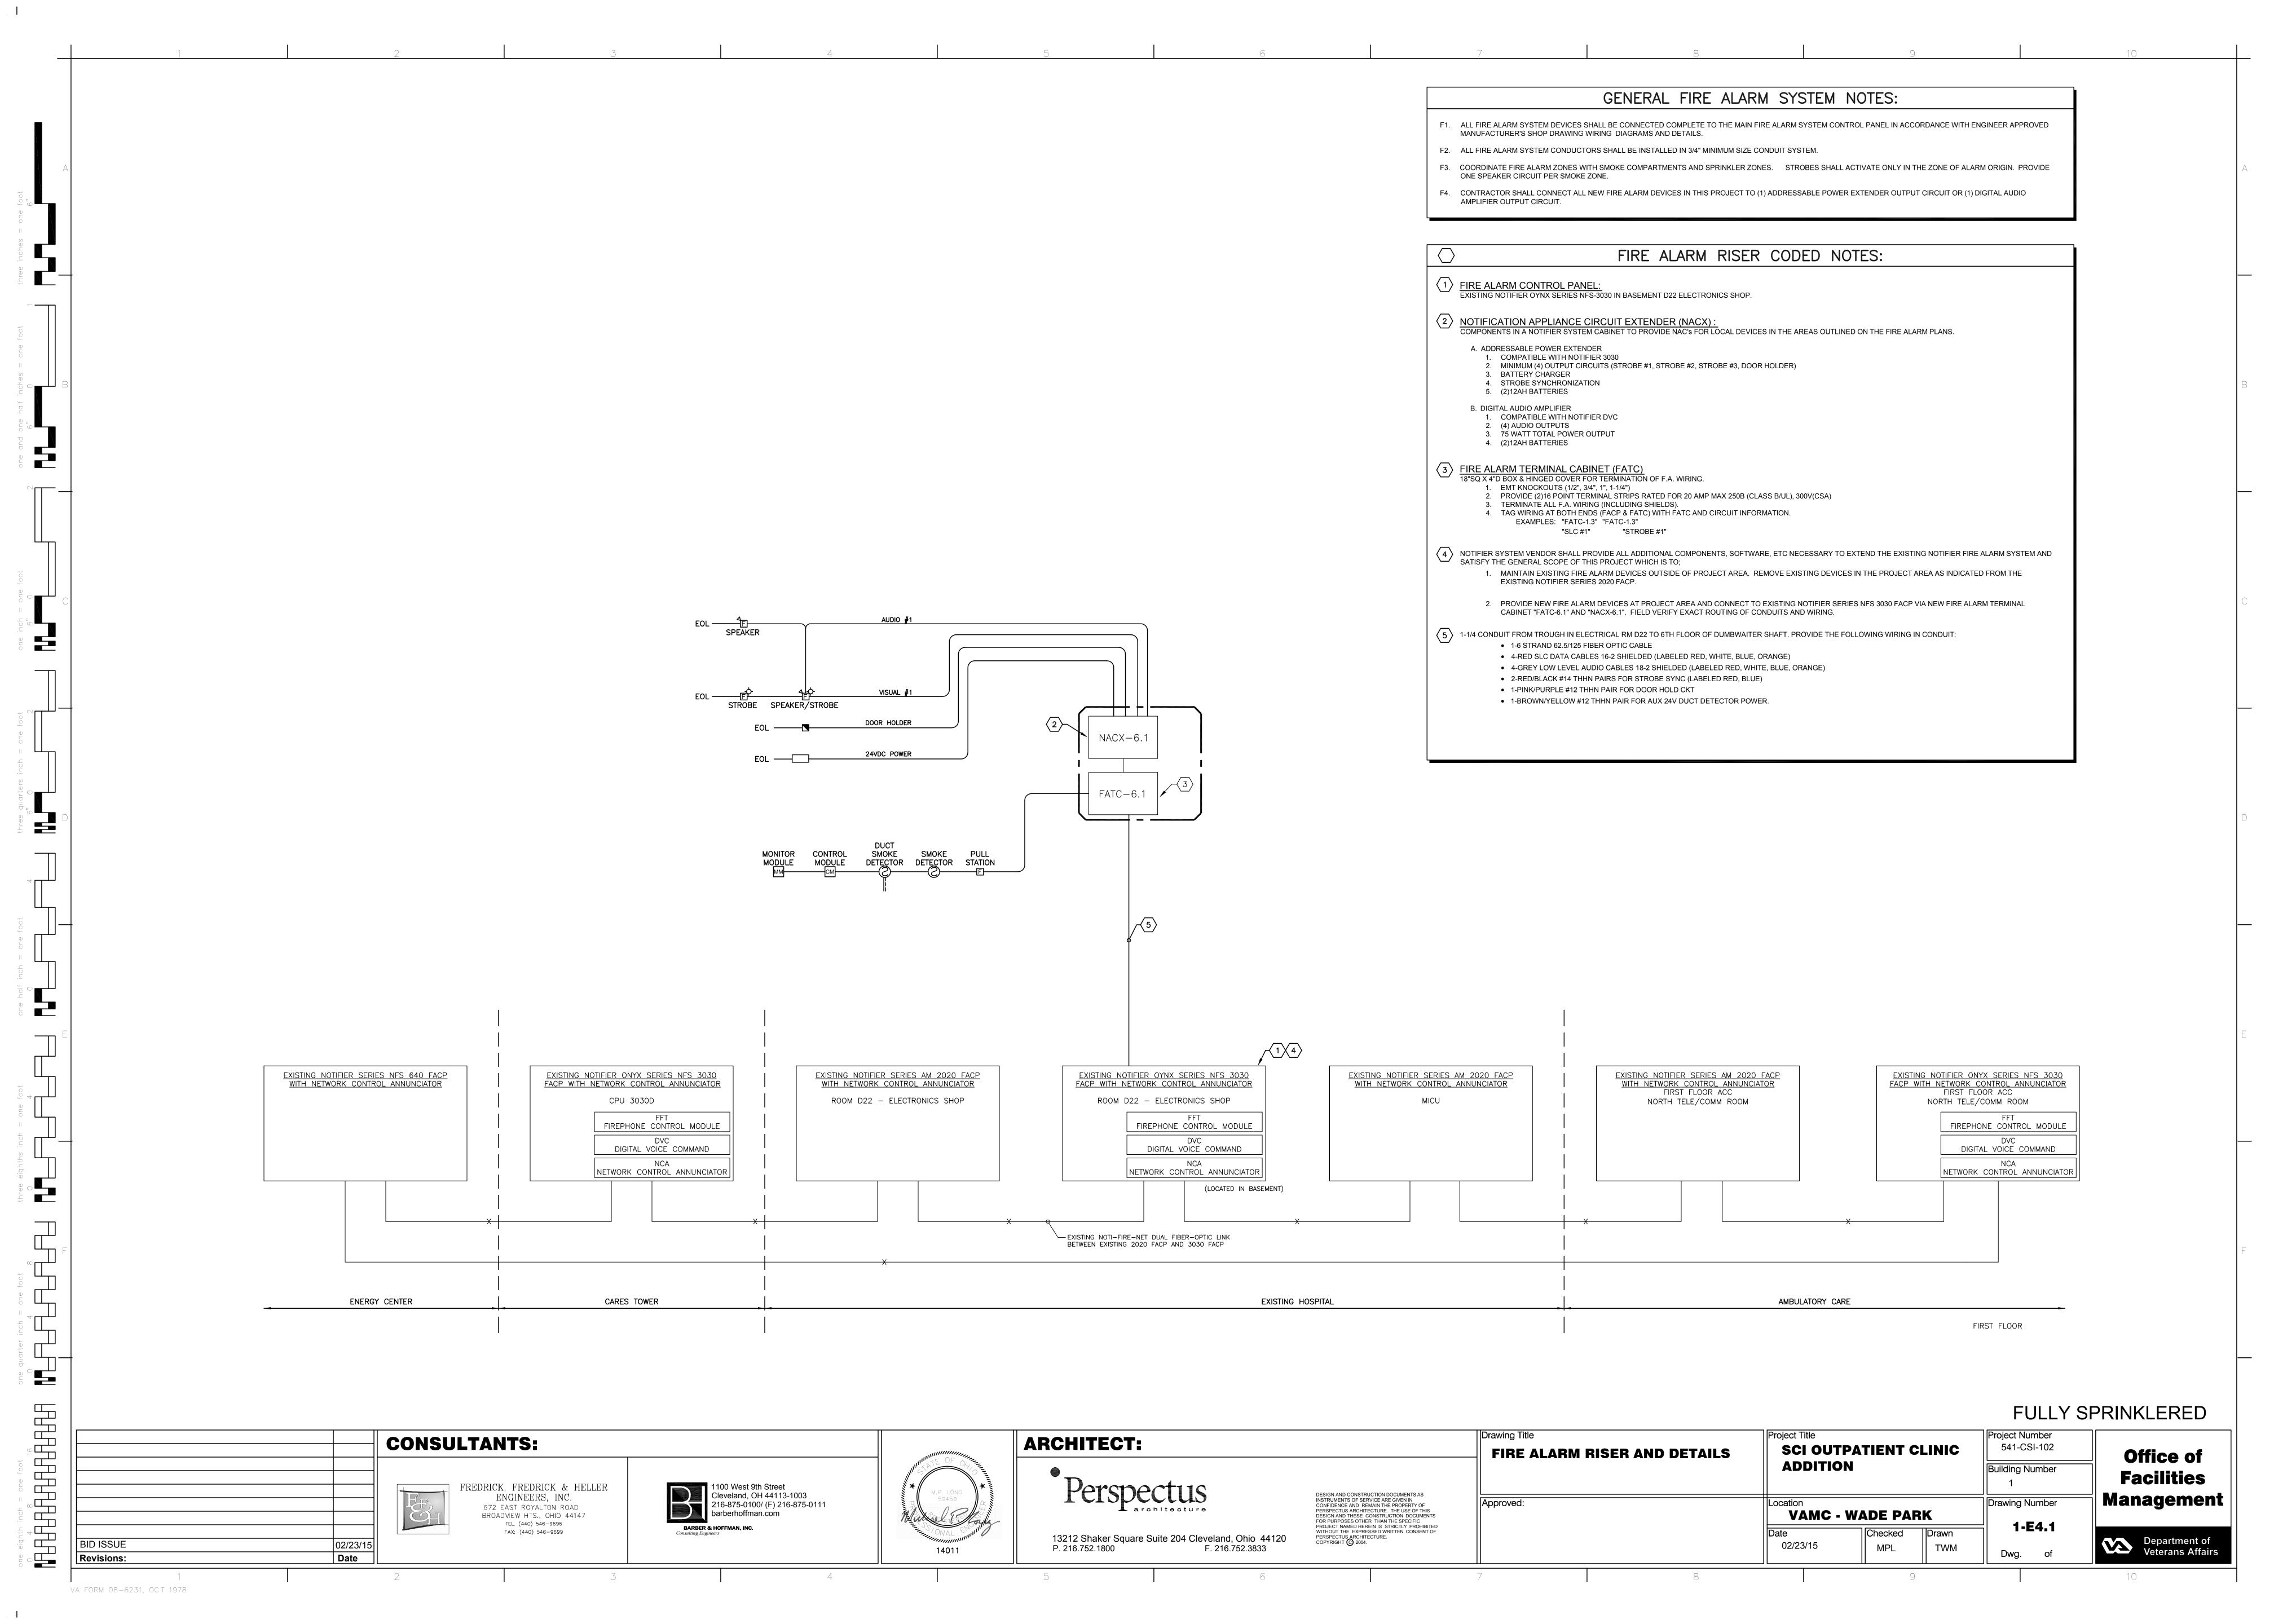
VA FORM 08-6231. OCT 1978


Date


**BID ISSUE** 

Revisions:





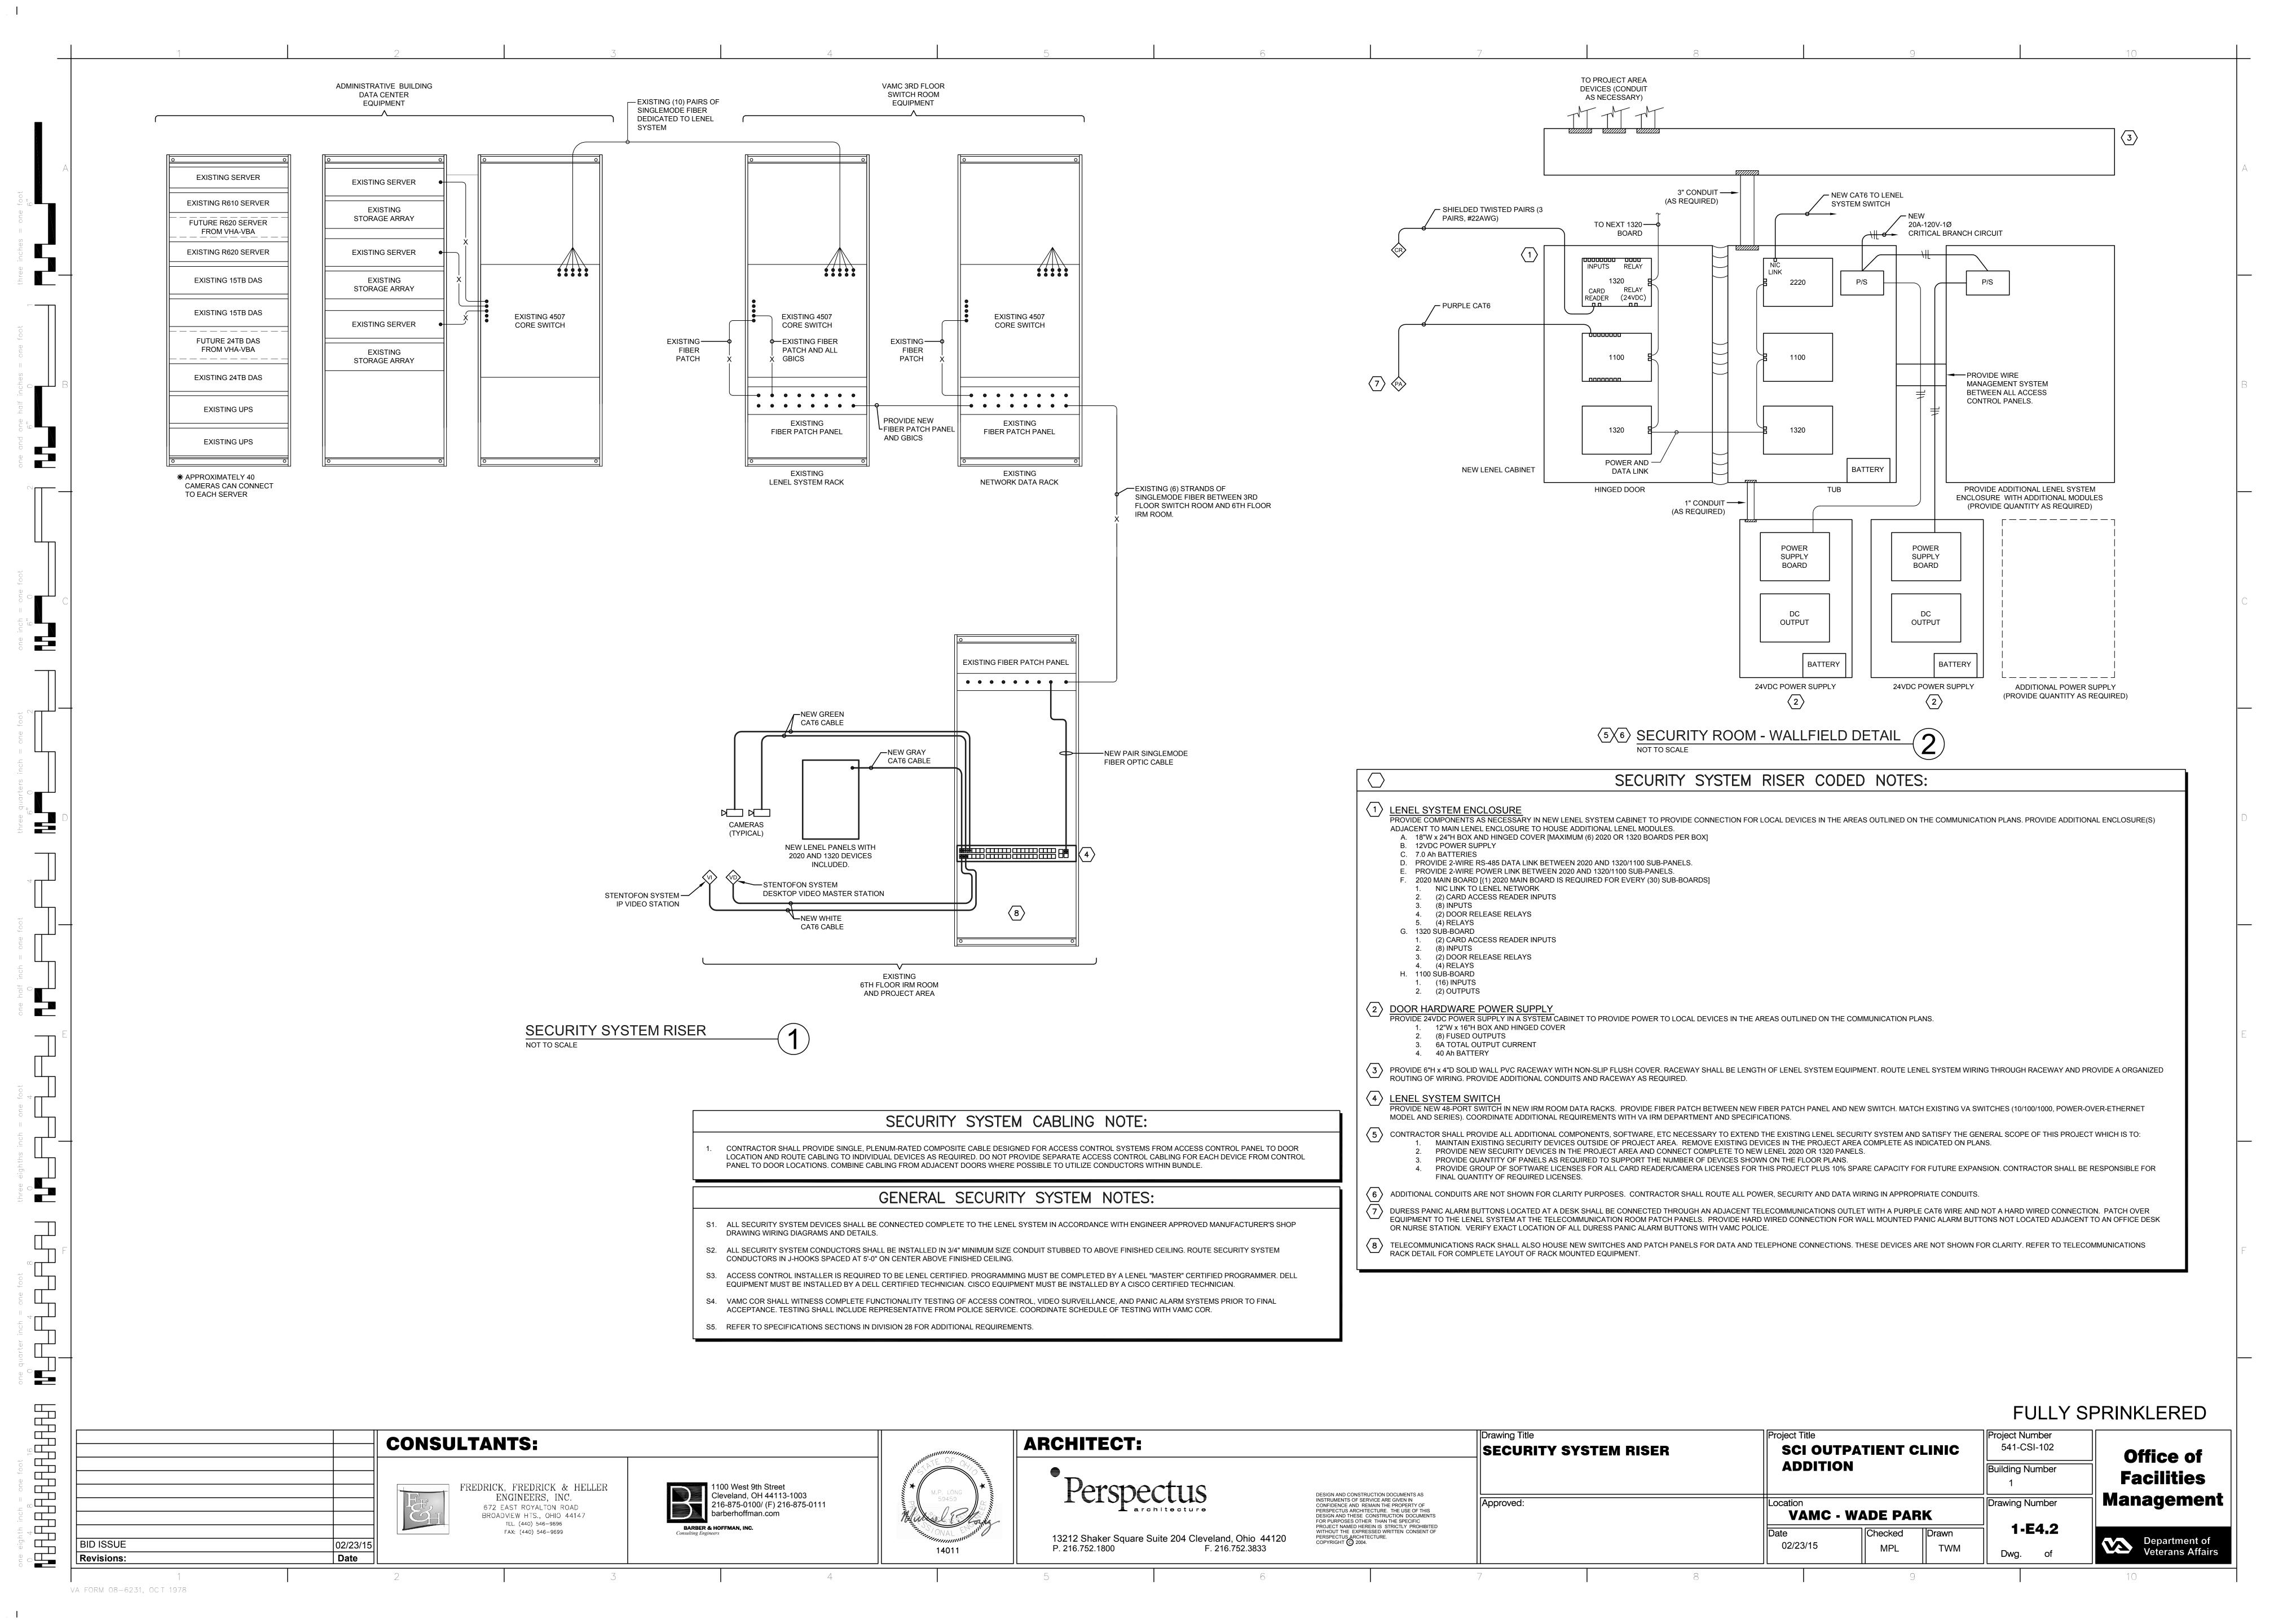

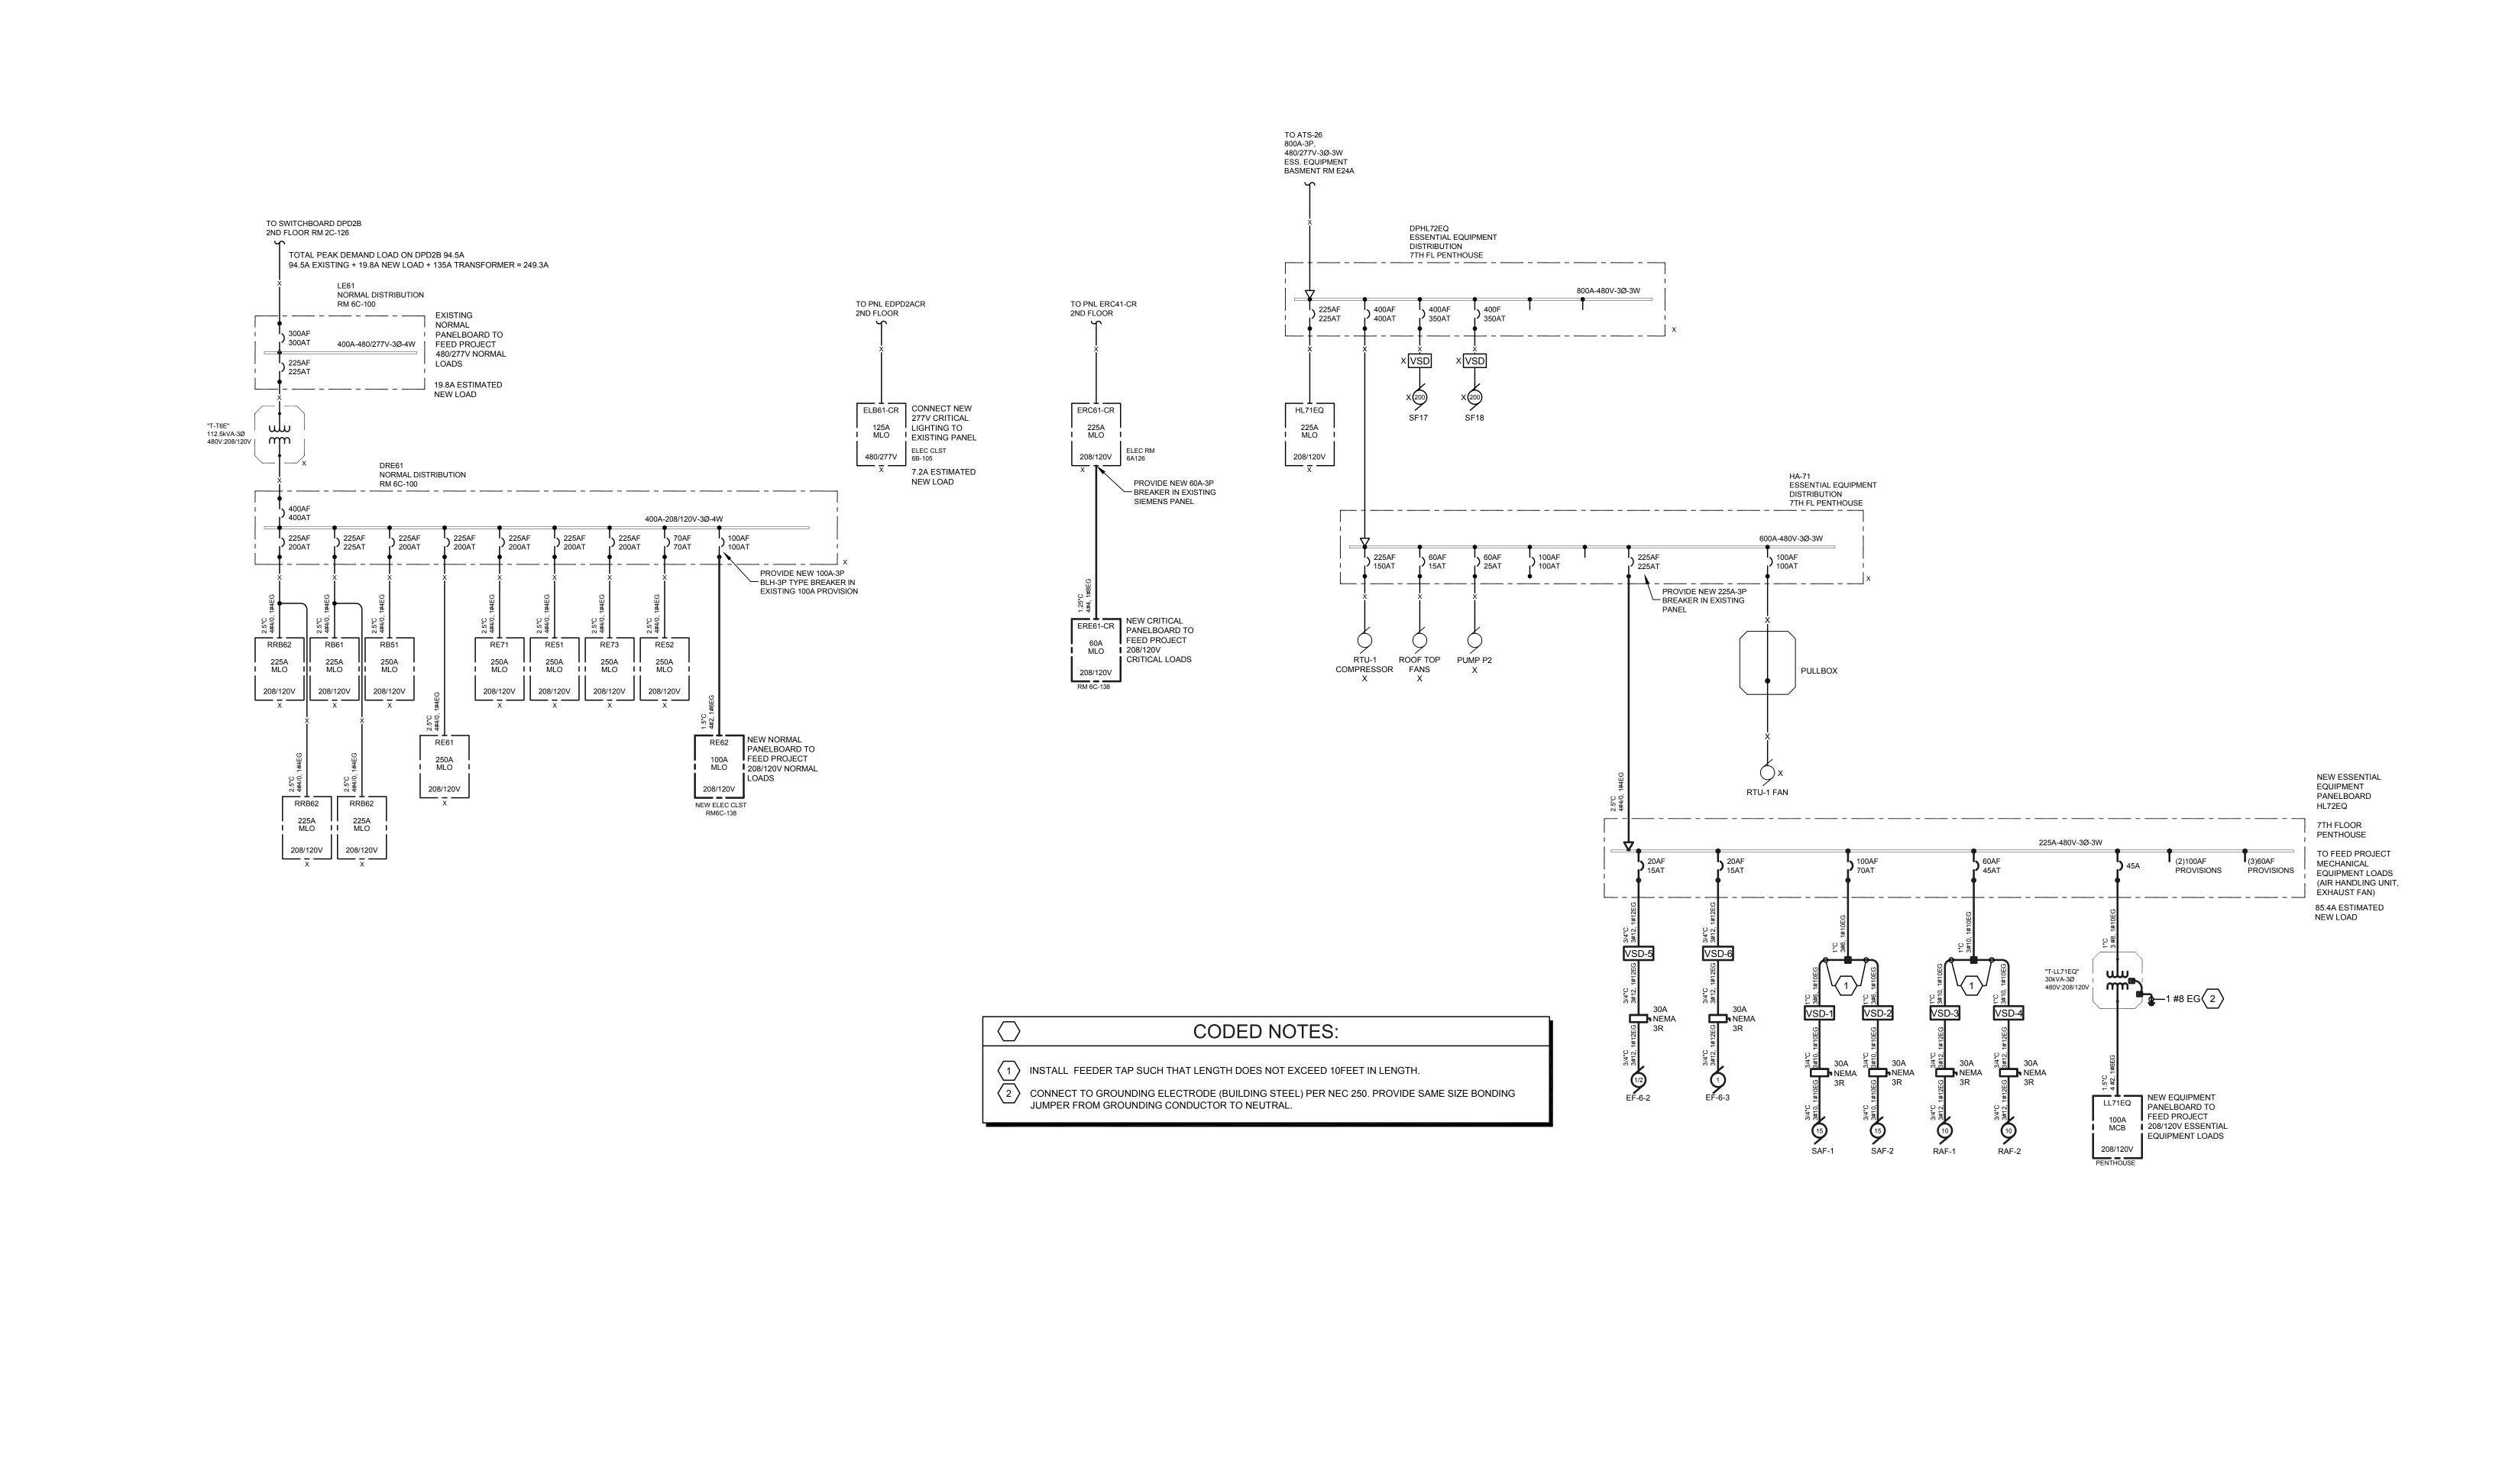


### **FULLY SPRINKLERED**

Drawing Title Project Title Project Number **CONSULTANTS: ARCHITECT: POWER DISTRIBUTION** 541-CSI-102 SCI OUTPATIENT CLINIC Office of ONE-LINE DIAGRAM **ADDITION** Building Number **Facilities** 1100 West 9th Street Cleveland, OH 44113-1003 216-875-0100/ (F) 216-875-0111 barberhoffman.com FREDRICK, FREDRICK & HELLER DESIGN AND CONSTRUCTION DOCUMENTS AS INSTRUMENTS OF SERVICE ARE GIVEN IN CONFIDENCE AND REMAIN THE PROPERTY OF PERSPECTUS ARCHITECTURE. THE USE OF THIS DESIGN AND THESE CONSTRUCTION DOCUMENTS FOR PURPOSES OTHER THAN THE SPECIFIC PROJECT NAMED HEREIN IS STRICTLY PROHIBITED WITHOUT THE EXPRESSED WRITTEN CONSENT OF PERSPECTUS ARCHITECTURE. COPYRIGHT © 2004. Management ENGINEERS, INC. Drawing Number Approved: \_ocation 672 EAST ROYALTON ROAD **VAMC - WADE PARK** BROADVIEW HTS., OHIO 44147 TEL. (440) 546-9696 1-E4.3 BARBER & HOFFMAN, INC. FAX: (440) 546-9699 Checked 13212 Shaker Square Suite 204 Cleveland, Ohio 44120 P. 216.752.1800 F. 216.752.3833 Department of Veterans Affairs Department of BID ISSUE 02/23/15 02/23/15 MPL TWM Dwg. Date Revisions:

POWER DISTRIBUTION

ONE-LINE DIAGRAM

NOT TO SCALE

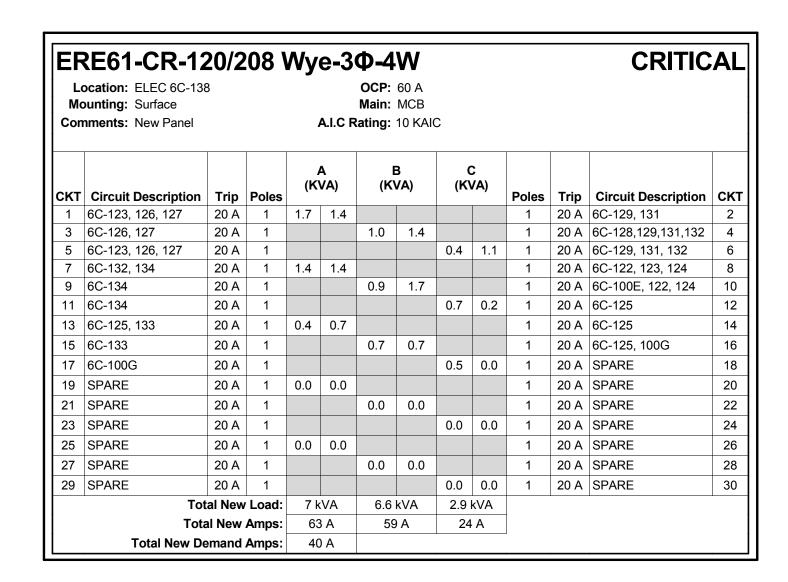

Lo Mo	ccation: ELEC 6C-138 counting: Surface nments: New Panel					OCP: Main: ating:	MCB	C					
СКТ	Circuit Description	Trip	Poles	_	A VA)	(K\	3 /A)	(K\		Poles	Trip	Circuit Description	СКТ
1	6C-129, 131, 132	20 A	1	0.9	0.9					1	20 A	6C-123, 126, 127	2
3	6C-128,129,131,132	20 A	1			1.3	0.7			1	20 A	, -,	4
5	6C-129, 131, 132	20 A	1					0.9	0.7	1	20 A		6
7	6C-124, 137	20 A	1	1.1	0.9					1	20 A	· · ·	8
9	6C-124, 137	20 A	1			0.9	0.9			1		6C-134, 135, 136	10
11	6C-125	20 A	1					1.5	0.7	1		6C-134, 135, 136	12
13	SPARE	20 A	1	0.0	1.1					1	20 A	, , , , ,	14
15	6C-100,130,125,123	20 A	1			1.1	1.1			1		6C-100, 112, 138	16
17	SPARE	20 A	1					0.0	0.0	1	20 A	SPARE	18
19	SPARE	20 A	1	0.0	0.0					1	20 A	SPARE	20
21	SPARE	20 A	1			0.0	0.0			1	20 A	SPARE	22
23	SPARE	20 A	1					0.0	0.0	1	20 A	SPARE	24
25	SPARE	20 A	1	0.0	0.0					1	20 A	SPARE	26
27	SPARE	20 A	1			0.0	0.0			1	20 A	SPARE	28
29	SPARE	20 A	1					0.0	0.0	1	20 A	SPARE	30
31	SPARE	20 A	1	0.0	0.0					1	20 A	SPARE	32
33	SPARE	20 A	1			0.0	0.0			1	20 A	SPARE	34
35	SPARE	20 A	1					0.0	0.0	1	20 A	SPARE	36
	Tot	al New	Load:	4.9	kVA	5.9	kVA	3.81	kVA			I	
	Tota	Amps:	42	2 A	51	Α	32	Α					
	Total New De	emand	Amps:	34	ł A			1		1			

Mo	ocation: Penthouse 70 ounting: Surface nments: New Panel		A.I.C R	OCP: Main: ating:		IC							
СКТ		Trip	Poles		A VA)	-	3 /A)	(K)	C /A)	Poles	Trip	Circuit Description	СКТ
1	EF-6-3 - VSD-6	15 A	3	1.3	3.7					3	15 A	EF-6-2 - VSD-5	2
3						1.3	3.7						4
5								1.3	3.7				6
7	T-LL71EQ	45 A	3	0.4	11.5					3	45 A	RETURN - VSD-3,4	8
9						0.8	11.5						10
11								0.2	11.5				12
13	SUPPLY - VSD-1,2	70 A	3	19.1	0.0					3	60 A	PROVISION	14
15						19.1	0.0				-		16
17								19.1	0.0		-		18
19	ELECT CHAIN	20 A	3	0.0	0.0					3	60 A	PROVISION	20
21						0.0	0.0				-		22
23								0.0	0.0				24
25	PROVISION	100 A	3	0.0	0.0					3	100 A	PROVISION	26
27						0.0	0.0						28
29								0.0	0.0		-		30
	Tot	al New	Load:	36	kVA	36.4	kVA	35.7	kVA			I	1
	Tota	al New	Amps:	13	0 A	13	2 A	129	9 A				
	Total New De	128 A						I					

Lo Mo	61-480/277 ocation: ELEC 6C-100 ounting: Surface nments: Existing Pane			OCP: Main:	400 A MCB 65 KAI	С				NORM			
СКТ	Circuit Description	Trip	Poles		A	ı	В	(	<b>.</b>	Poles	Trip	Circuit Description	СК
1	LTG CORRIDOR	20 A	1	1.7	0.0					1	20 A	LTG EXISTING	2
3	SPARE	20 A	1			0.0	0.0			1	20 A	LTG EXISTING	4
5	SPARE	20 A	1					0.0	0.0	1	20 A	SPARE	6
7	SPARE	20 A	1	0.0	0.0					1	20 A	SPARE	8
9	SPARE	20 A	1			0.0	0.0	0.0	0.0	1	20 A	SPARE	10
11	SPARE	20 A	1					0.0	0.0	1	20 A	SPARE	12
13	SPARE	20 A	1	0.0	0.0					1	20 A	SPARE	14
15	SPARE	20 A	1			0.0	0.0			1	20 A	SPARE	16
17	SPARE	20 A	1					0.0	0.0	1	20 A	SPARE	18
19	SPARE	20 A	1	0.0	0.0					1	20 A	PROVISION	20
21	PROVISION					0.0	0.0			1	20 A	PROVISION	2
23	PROVISION							0.0	0.0	1	20 A	PROVISION	24
25	LE71	200 A	3	0.0	0.0					3	200 A	T-T6E	26
27						0.0	0.0						28
29			-					0.0	0.0				30
31	PROVISION	250 A	3	0.0	0.0					3	250 A	PROVISION	32
33						0.0	0.0						34
35								0.0	0.0				36
37	SPARE	20 A	2	0.0	0.0							PROVISION	38
39						0.0	0.0					PROVISION	40
41	PROVISION							0.0	0.0			PROVISION	42
	Tot	al New	Load:	1.7	kVA	0 k	VΑ	0 kVA			Ī	I	1
	Tota	al New	Amps:	6	Α	0	Α	0	Α				
	Total New De	emand	Amps:	2	Α			1		1			

Lo Mo	B61CR-480 cation: ELEC 6B105 cunting: Surface nments: Existing Pane		77 W			O-4V OCP: Main: Rating:	125 A MLO					CRITICAL		
СКТ	Circuit Description	Trip	Poles		A.I.O N	_	3	(	<b>.</b>	Poles	Trip	Circuit Description	CK	
1	LTG WARD 61,63	20 A	1	0.0	0.0					1	20 A	SPARE	2	
3	EMERG LTG	20 A	1			1.9	0.0			1	20 A	SPARE	4	
5	SPARE	20 A	1					0.0	0.0	1	20 A	SPARE	6	
7	SPARE	20 A	1	0.0	0.0					1	20 A	SPARE	8	
9	SPARE	20 A	1			0.0	0.0			1	20 A	SPARE	10	
11	SPARE	20 A	1					0.0	0.0	1	20 A	SPARE	12	
13	SPARE	20 A	1	0.0	0.0					1	20 A	SPARE	14	
15	SPARE	20 A	1			0.0	0.0			1	20 A	SPARE	16	
17	SPARE	20 A	1					0.0	0.0	1	20 A	SPARE	18	
19	SPARE	20 A	1	0.0	0.0							PROVISION	20	
21	SPARE	20 A	1			0.0	0.0					PROVISION	22	
23	SPARE	20 A	1					0.0	0.0			PROVISION	24	
25	PROVISION			0.0	0.0							PROVISION	26	
27	PROVISION					0.0	0.0					PROVISION	28	
29	PROVISION							0.0	0.0			PROVISION	30	
	Tot	al New	Load:	0 k	:VA	1.9	kVA	0 k	VA		I	I		
		al New			A	7 A		0 A		-				
	Total New De		-	2	Α					J				

Mo	ocation: Penthouse 70 ounting: Surface nments: New Panel	,	A.I.C R	OCP: Main: Rating:		С							
СКТ	Circuit Description	Trip	Poles		A VA)	_	B VA)	(K)	C /A)	Poles	Trip	Circuit Description	скт
1	AHU LTG,REC	20 A	1	0.2	0.2					1	20 A	EF6-1	2
3	AHU LTG,REC	20 A	1			0.2	0.7			1	20 A	ROOFTOP REC	4
5	AHU,LTG.REC	20 A	1					0.2	0.0	1	20 A	SPARE	6
7	SPARE	20 A	1	0.0	0.0					1	20 A	SPARE	8
9	SPARE	20 A	1			0.0	0.0			1	20 A	SPARE	10
11	SPARE	20 A	1					0.0	0.0	1	20 A	SPARE	12
13	SPARE	20 A	1	0.0	0.0					1	20 A	SPARE	14
15	SPARE	20 A	1			0.0	0.0			1	20 A	SPARE	16
17	SPARE	20 A	1					0.0	0.0	1	20 A	SPARE	18
19	SPARE	20 A	1	0.0	0.0					1	20 A	SPARE	20
21	SPARE	20 A	1			0.0	0.0			1	20 A	SPARE	22
23	SPARE	20 A	1					0.0	0.0	1	20 A	SPARE	24
25	SPARE	20 A	1	0.0	0.0					1	20 A	SPARE	26
27	SPARE	20 A	1			0.0	0.0			1	20 A	SPARE	28
29	SPARE	20 A	1					0.0	0.0	1	20 A	SPARE	30
	Tot	0.4	kVA	0.8 kVA		0.2 kVA			I	I	1		

Drawing Title

FULLY SPRINKLERED


**CONSULTANTS:** BID ISSUE 02/23/15 Date Revisions:

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Consulting Engineers





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POWER DISTRIBUTION PANEL SCI OUTPATIENT CLINIC **BOARD SCHEDULES ADDITION** Approved: **VAMC - WADE PARK** Drawn Checked 02/23/15 MPL

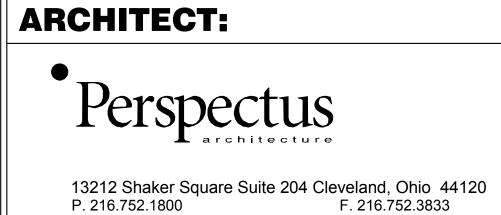
Project Title

Project Number 541-CSI-102 Office of Building Number **Facilities** Management Drawing Number 1-E5.1

TWM


Dwg.



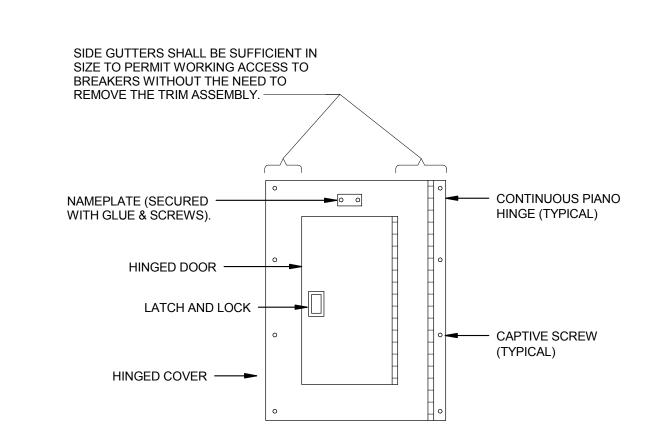


- 1. ALL NEW PANELBOARDS SHALL BE PROVIDED WITH <u>SUB-FEED LUGS</u> AND SUFFICIENT SIZE WIRING GUTTERS TO ACCOMMODATE ALL FEEDERS (INCLUDING FUTURE) IN A CODE COMPLYING MANNER. FEED THROUGH LUGS ARE <u>NOT</u> ACCEPTABLE.
- 2. ALL PANELBOARDS SHALL IDENTIFIED WITH AN ENGRAVED PHENOLIC NAMEPLATE. REFER TO DISTRIBUTION EQUIPMENT NAMEPLATE DETAILS FOR ADDITIONAL INFORMATION.
- 3. REFER TO SPECIFICATIONS FOR PANELBOARD CONSTRUCTION REQUIREMENTS REGARDING BUS, DIRECTORIES, FINISHES, ETC.
- 4. ONE MONTH AFTER OCCUPANCY BY THE OWNER, THE ELECTRICAL CONTRACTOR SHALL MEASURE AND RECORD THE FEEDER PHASE CURRENTS FOR ALL NEW AND EXISTING PANELBOARDS ASSOCIATED WITH THIS PROJECT, AND SHALL SUBMIT DATA TO ENGINEER.
- 5. PROVIDE UPDATED <u>TYPED</u> SCHEDULES IN EXISTING PANELS, AND NEW SCHEDULES IN NEW PANELS. SCHEDULE DESCRIPTIONS SHALL INCLUDE <u>TYPE OF LOAD</u> (RECEPTACLES, LIGHTING, EWC, ETC.) AND <u>ROOM NUMBER</u> WHERE LOAD IS LOCATED.
- 6. CIRCUIT ASSIGNMENTS ARE FOR REFERENCE ONLY. CONTRACTOR SHALL VERIFY AVAILABILITY PRIOR TO ROUGH-IN AND ORDERING ENGRAVED COVERPLATES. REPORT ANY DEVIATIONS TO ENGINEER FOR APPROVAL.

PANELBOARD CONSTRUCTION DETAIL NOT TO SCALE

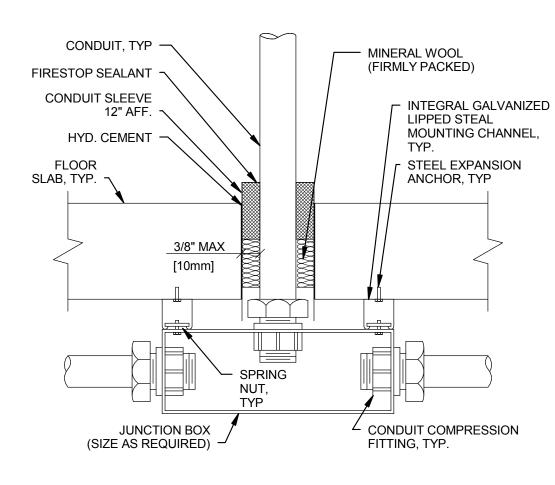


FLOOR PENETRATION DETAIL NOT TO SCALE

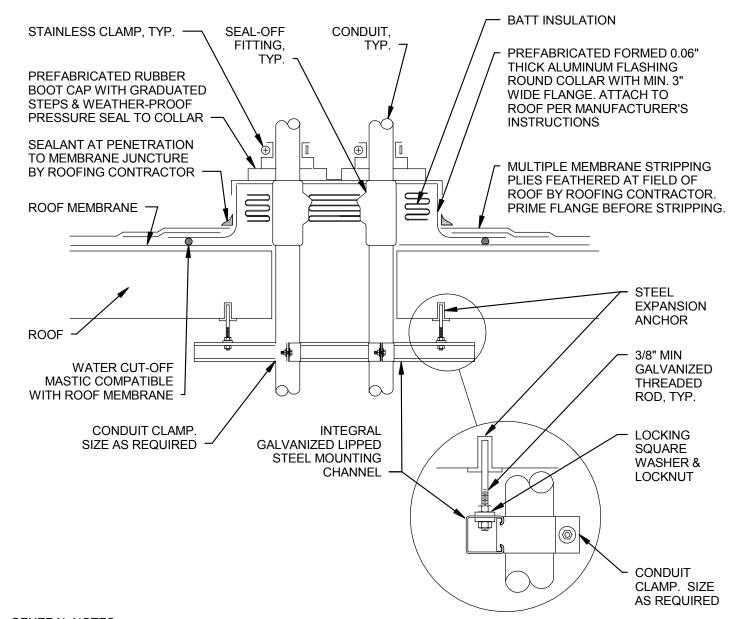

**GENERAL NOTES:** 

- 1. MAINTAIN A MINIMUM CLEARANCE OF 12" ON ALL SIDES OF ROOF PENETRATION FROM WALLS, CURBS, AND OTHER PROJECTIONS TO FACILITATE PROPER FLASHING.
- 2. FLANGES OF ADJACENT FLASHINGS SHALL NOT BE CUT OR OVERLAPPED.
- 3. VERIFY ROOF & STRUCTURAL SYSTEM WITH ARCHITECT.
- 4. COORDINATE FLASHING INSTALLATION WITH ROOFING CONTRACTOR TO ENSURE PROPER METHODS & MATERIALS ARE USED TO MAINTAIN ROOF WARRANTY.
- 5. COORDINATE PENETRATION LOCATIONS WITH OTHER TRADES TO MAXIMIZE USAGE OF PENETRATION CURBS.

ROOF PENETRATION DETAIL NOT TO SCALE

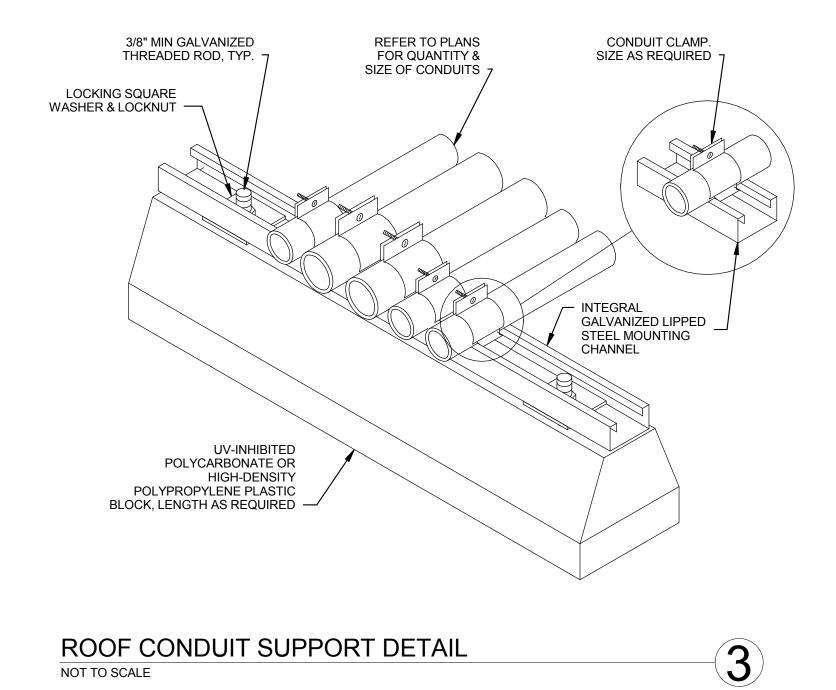

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PANELBOARD NAMEPLATE RPE 175AMP, 208/120V-3P-4W NORMAL FED FROM: LPE LOCATION: 1ST FL. ELECTRICAL RM.

### NAMEPLATE REQUIREMENTS:

- PROVIDE AN IDENTIFICATION SIGN WHICH CLEARLY INDICATES ELECTRICAL SYSTEM INFORMATION FOR PANELBOARDS, DISTRIBUTION PANELS, SWITCHBOARDS, MOTOR CONTROL CENTERS, AUTOMATIC TRANSFER SWITCHES.
- PROVIDE ENGRAVED 1/2"H (MIN.) LETTERING ON PHENOLIC NAMEPLATE WITH THE FOLLOWING COLOR FORMAT:
- A. 208/120 VOLTS (NORMAL) GREEN BACKGROUND, WHITE LETTERS B. 480/277 VOLTS (NORMAL) - BLACK BACKGROUND, WHITE LETTERS
- C. 208/120 VOLTS (EMERG.) WHITE BACKGROUND, RED LETTERS D. 480/277 VOLTS (EMERG.) - RED BACKGROUND, WHITE LETTERS
- REFER TO ELECTRICAL SPECIFICATIONS FOR ADDITIONAL INFORMATION.


DISTRIBUTION **EQUIPMENT NAMEPLATE DETAIL** NOT TO SCALE

- PROVIDE JUNCTION BOX AFC FOR FUTURE REMOTE TRANSFORMER 1/2"C CONCEALED IN WALL. PROVIDE J-BOX MOUNTED ON WALL BEHIND SINK. **ELECTRONIC SINK CONTROL** ROUGH-IN WIRING DETAIL NOT TO SCALE


- 120V BRANCH CCT. BY E.C. SEE MECHANICAL CONNECTIONS FLOOR PLAN FOR CCT. NO.

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		CONSULTANTS:		11 111111111111111111111111111111111111	ARCHITECT:		Drawing Title  ELECTRICAL DETAILS	Project Title  SCI OUTPATIENT CLINIC	Project Number 541-CSI-102	Office of
		FREDRICK, FREDRICK & HELLER	2217 East 9th Street, Suite 350	THE OF ON THE OT	Doronoctuo			ADDITION	Building Number  1	Facilities
		ENGINEERS, INC.  672 EAST ROYALTON ROAD BROADVIEW HTS., OHIO 44147 TEL. (440) 546-9696 FAX: (440) 546-9699	2217 East 9th Street, Suite 350 Cleveland, OH 44115-1257 216-875-0100/ (F) 216-875-0111 barberhoffman.com	M.P. LONG 59459	Perspectus	DESIGN AND CONSTRUCTION DOCUMENTS AS INSTRUMENTS OF SERVICE ARE GIVEN IN CONFIDENCE AND REMAIN THE PROPERTY OF PERSPECTUS ARCHITECTURE. THE USE OF THIS DESIGN AND THESE CONSTRUCTION DOCUMENTS FOR PURPOSES OTHER THAN THE SPECIFIC	Approved:	Location VAMC - WADE PARK	Drawing Number	Management
1 I F	BID ISSUE		BARBER & HOFFMAN, INC.  Consulting Engineers		13212 Shaker Square Suite 204 Cleveland, Ohio 44120 P. 216.752.1800 F. 216.752.3833	PROJECT NAMED HEREIN IS STRICTLY PROHIBITED WITHOUT THE EXPRESSED WRITTEN CONSENT OF PERSPECTUS ARCHITECTURE. COPYRIGHT © 2004.		Date Checked Drawn 02/23/15 MPL TWM	<b>1-E6.1</b> Dwg. of	Department of Veterans Affairs

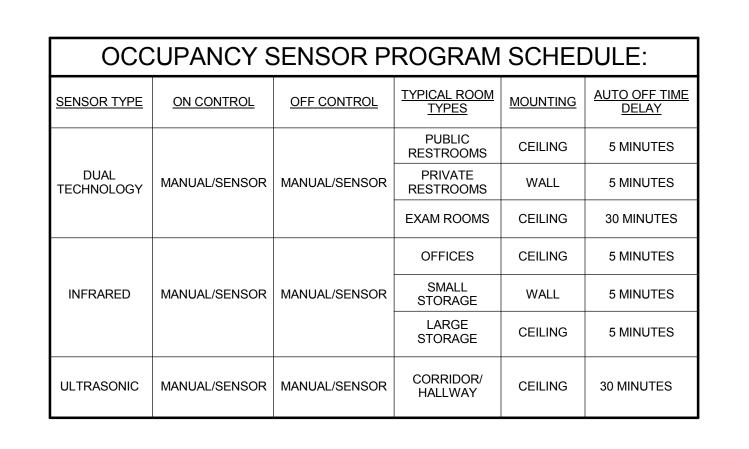

OCCUPANCY SENSOR PROGRAM SCHEDULE NOT TO SCALE

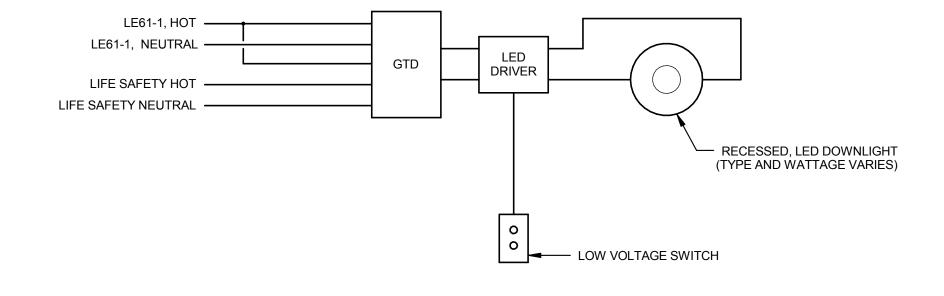

NOTES:

1. EQUIPMENT GROUND IS REQUIRED BUT IS NOT SHOWN ON THIS WIRING DIAGRAM FOR CLARITY.
2. DIMMED AND SWITCHED HOT WIRES ARE SHOWN AS A SINGLE LINE ON THIS WIRING DIAGRAM FOR CLARITY, REFER TO MANUFACTUER'S DIAGRAMS FOR DETAILED WIRING REQUIRMENTS.

TYPICAL GTD WIRING DIAGRAM NOT TO SCALE


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**CONSULTANTS:** 02/23/15 BID ISSUE Date Revisions:

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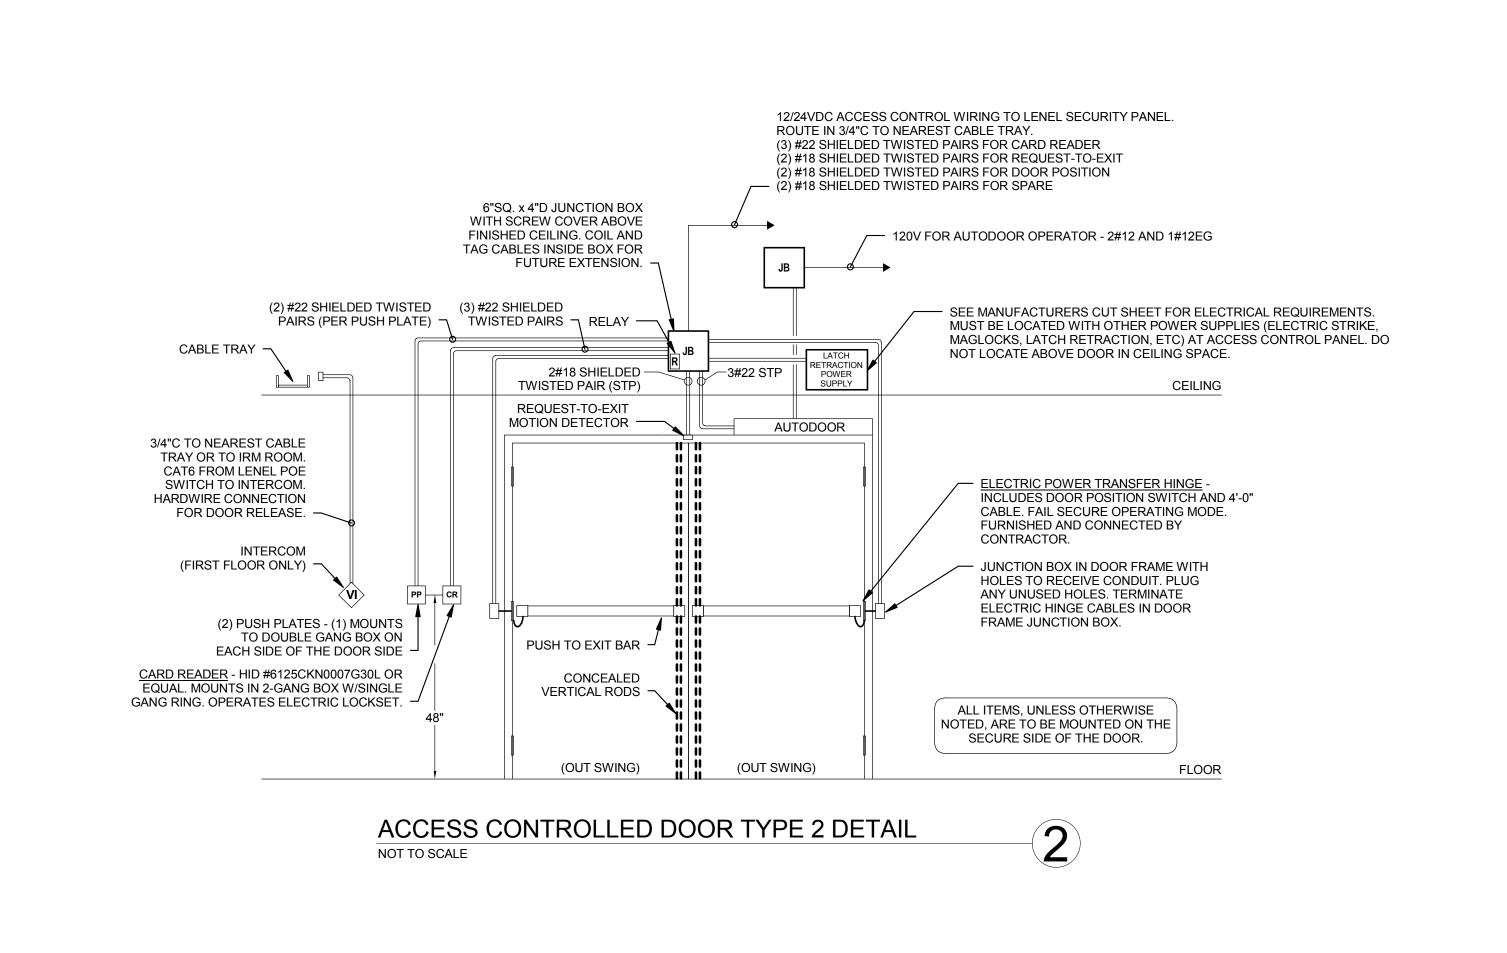


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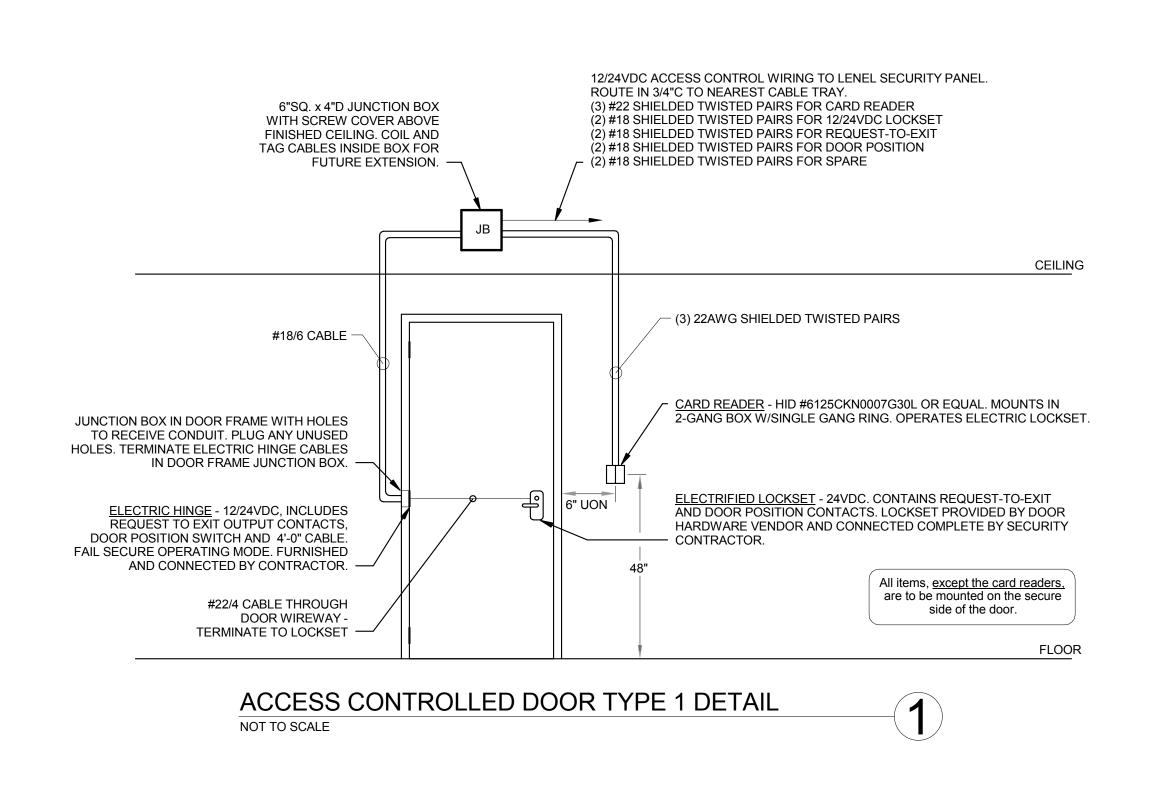
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VA FORM 08-6231, OCT 1978



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Drawing Title Project Title Project Number **ARCHITECT: CONSULTANTS:** 541-CSI-102 SECURITY DETAILS SCI OUTPATIENT CLINIC Office of **ADDITION** Building Number **Facilities** 2217 East 9th Street, Suite 350 Cleveland, OH 44115-1257 216-875-0100/ (F) 216-875-0111 FREDRICK, FREDRICK & HELLER DESIGN AND CONSTRUCTION DOCUMENTS AS INSTRUMENTS OF SERVICE ARE GIVEN IN CONFIDENCE AND REMAIN THE PROPERTY OF PERSPECTUS ARCHITECTURE. THE USE OF THIS DESIGN AND THESE CONSTRUCTION DOCUMENTS FOR PURPOSES OTHER THAN THE SPECIFIC PROJECT NAMED HEREIN IS STRICTLY PROHIBITED WITHOUT THE EXPRESSED WRITTEN CONSENT OF PERSPECTUS ARCHITECTURE. COPYRIGHT © 2004. Management ENGINEERS, INC. Drawing Number Approved: 672 EAST ROYALTON ROAD **VAMC - WADE PARK** barberhoffman.com BROADVIEW HTS., OHIO 44147 TEL. (440) 546-9696 FAX: (440) 546-9699 1-E6.3 BARBER & HOFFMAN, INC. Drawn Checked 13212 Shaker Square Suite 204 Cleveland, Ohio 44120 Department of Veterans Affairs BID ISSUE 02/23/15 02/23/15 TWM MPL P. 216.752.1800 F. 216.752.3833 Dwg. Date **Revisions:** 
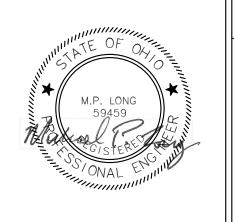
#### TELECOMMUNICATIONS LEGEND

- TELECOMMUNICATIONS OUTLET "TCO" MOUNTED AT 18" AFF UNLESS OTHERWISE NOTED. REFER TO TELECOMMUNICATIONS OUTLET DETAILS ON SUBSEQUENT DRAWING FOR REQUIREMENTS.
- PATIENT MONITORING OUTLET WALL MOUNTED, COORDINATE WITH MONITOR MOUNTING BRACKET. REFER TO PATIENT MONITORING OUTLET DETAILS ON SUBSEQUENT DRAWING FOR REQUIREMENTS.
- TELECOMMUNICATIONS OUTLET "TCO" CEILING MOUNTED. REFER TO TELECOMMUNICATIONS OUTLET DETAILS ON SUBSECUENT DEAMING FOR RECURSEASTICS. SUBSEQUENT DRAWING FOR REQUIREMENTS.
- W ▶ TELEPHONE OUTLET- MOUNTED AT 48" AFF UNLESS OTHERWISE NOTED.
- TELECOMMUNICATIONS OUTLET "TCO" ROUGH-IN ONLY (BACKBOX AND CONDUIT STUBBED TO ABOVE FINISHED CEILING).
- WIRELESS ACCESS OUTLET 2-PORT SURFACE MOUNTED DATA BOX MOUNTED ABOVE FINISHED CEILING. WIRELESS ACCESS POINTS ARE PROVIDED BY OWNER.

12"W x 4"D (MINIMUM SIZE) CABLE TRAY WIRE MANAGEMENT SYSTEM. MOUNTED ABOVE ACCESSIBLE CEILING. COORDINATE LOCATION WITH OTHER TRADES. MAINTAIN 6" WORKING CLEARANCE ABOVE AND BELOW CABLE TRAY AT ALL LOCATIONS.

> TELECOMMUNICATION CONNECTION WALL BOX FOR PRE-WIRED FURNITURE - 4" SQ. JUNCTION BOX MOUNTED AT 18" AFF FOR TELECOMMUNICATIONS CONNECTION TO TCO'S IN FURNITURE. VERIFY THE QUANTITY OF TCO CABLES REQUIRED FOR FURNITURE. OWNER SHALL TERMINATE ALL TCO CABLES.

#### TELECOMMUNICATIONS SYSTEM NOTES:

- T1. REFER TO TECHNOLOGY DETAILS FOR ADDITIONAL INFORMATION.
- T2. REFER TO SPECIFICATIONS FOR ADDITIONAL INFORMATION.
- T3. CONTRACTOR SHALL PROVIDE DEVICES, CABLING, TESTING, AND TERMINATIONS. TEST COMPLETE INSTALLATION IN ACCORDANCE WITH VA STANDARDS AND SPECIFICATIONS.

#### NURSE CALL SYSTEM LEGEND

- POWER OVER ETHERNET SWITCH HILL-ROM AUDIO/VISUAL, RACK MOUNTED ENCLOSURE 1U (HILL-ROM #P2519NNC1A24). REFER TO SPECIFICATIONS FOR ADDITIONAL REQUIREMENTS.
- STAFF CONSOLE STATION LCD CONSOLE WITH DIGITAL DISPLAY, TONE AND TWO-WAY VOICE, WALL MOUNTED (HILL-ROM #PC2500NNC1A00). MOUNT CONSOLE AT 54" AFF INTO 4"SQ. x 3 1/2" MIN. DEPTH BOX FITTED WITH 1-GANG RAISED PLASTER RING.
- TELEVISION INTERFACE 1/4" RECEPTACLE MOUNTED IN COMMON MULTIMEDIA FACEPLATE WITH BROADBAND (CATV OUTLET FOR PATIENT BED
- TELEVISION. MOUNT AT 72" AFF.
- EQUIPMENT RECEPTACLE SINGLE STATION WITH CALL CANCEL CABLE DISCONNECT BUTTON AND EQUIPMENT JACK (HILL-ROM #P2516A01) -MOUNTED AT INTO 4"SQ. x 2 1/2" MIN. DEPTH BOX FITTED WITH 1-GANG RAISED PLASTER RING.

PATIENT STATION - GRAPHICAL ROOM STATION WITH CODE BLUE, DISPLAY AND INFRA-RED BUTTONS (HILL-ROM #P2594NNC2A11) - MOUNTED AT

- AUDIO STATION BED CONNECTOR SINGLE STATION WITH CALL CANCEL CABLE DISCONNECT BUTTON AND EQUIPMENT JACK (HILL-ROM
- #P2516A01) MOUNTED AT INTO 4"SQ. x 2 1/2" MIN. DEPTH BOX FITTED WITH 1-GANG RAISED PLASTER RING.
- 48" AFF IN 3-GANG x 3 1/2" D BACKBOX WITH 3-GANG RAISED PLASTER RING.
- STAFF STATION STANDARD ROOM STATION WITH CODE BLUE AND INFRA-RED BUTTONS (HILL-ROM #P2594NNC2A00) MOUNTED AT 48" AFF IN 3-GANG x 3 1/2" D BACKBOX WITH 3-GANG RAISED PLASTER RING.
- STAFF STATION GRAPHICAL ROOM STATION, DISPLAY AND INFRA-RED BUTTONS (HILL-ROM #P2594NNC2A00) MOUNTED AT 48" AFF IN 3-GANG x 3 1/2" D BACKBOX WITH 3-GANG RAISED PLASTER RING.
- STAFF STATION GRAPHICAL ROOM STATION WITH CODE BLUE, DISPLAY AND INFRA-RED BUTTONS (HILL-ROM #P2594NNC2A00) MOUNTED AT 48" AFF IN 3-GANG x 3 1/2" D BACKBOX WITH 3-GANG RAISED PLASTER RING.
- TOILET STATION WITH PULLCORD NYLON PULL-CORD, LED INDICATOR, CANCEL BUTTON, WATER-RESISTANT (HILL-ROM #P2520B01) MOUNTED
- SHOWER STATION WITH PULLCORD NYLON PULL-CORD, LED INDICATOR, CANCEL BUTTON, WATER-RESISTANT (HILL-ROM #P2520B01) -MOUNTED AT 48" AFF AT SHOWERS INTO 4"SQ. x 2 1/2" MIN. DEPTH BOX FITTED WITH 1-GANG RAISED PLASTER RING.

AT 42" AFF AT TOILETS INTO 4"SQ. x 2 1/2" MIN. DEPTH BOX FITTED WITH 1-GANG RAISED PLASTER RING.

- ROOM CONTROL BOARD REMOTE SWITCHES, CONNECT ALL ROOM DEVICES TO ROOM CONTROL BOARD. CONNECT ROOM CONTROL BOARD BACK TO POWER OVER ETHERNET SWITCH (HILL-ROM #P2599NNC1A00) - MOUNTED ABOVE CEILING IN 12"x12"x4"D JUNCTION BOX.
- REMOTE LOCATOR RECEIVER RECEIVERS STAFF BADGE SIGNAL WITH IR SIGNAL SENSORS (HILL-ROM #P2540B02) MOUNTED AT CEILING LEVEL
- DOME LIGHT 6-LED TYPE CEILING MOUNTED INTO 4"SQ. x 2 1/2" MIN. DEPTH BOX FITTED WITH 1-GANG RAISED PLASTER RING (HILL-ROM
- DOME LIGHT 1-LED TYPE CEILING MOUNTED INTO 4"SQ. x 2 1/2" MIN. DEPTH BOX FITTED WITH 1-GANG RAISED PLASTER RING (HILL-ROM #P2506NNC1A00).

### NURSE CALL SYSTEM NOTES:

- N1. SEE TECHNOLOGY DETAILS FOR NURSE CALL SYSTEM RISER DIAGRAMS.
- N2. MOUNT DEVICES AT MOUNTING HEIGHTS LISTED ABOVE UNLESS OTHERWISE NOTED ON THE FLOOR PLANS. COORDINATE EXACT MOUNTING LOCATION
- N3. CONTRACTOR SHALL VERIFY ALL BACKBOX SIZES WITH VA COR AND MANUFACTURER'S INSTALLATION INSTRUCTIONS PRIOR TO ROUGH-IN.
- N4. NURSE CALL SYSTEM ROUGH-INS, CONDUIT, EQUIPMENT, CABLING AND PULLWIRE SHALL BE PROVIDED BY CONTRACTOR.

INTO 4"SQ. x 2 1/2" MIN. DEPTH BOX FITTED WITH 2-GANG RAISED PLASTER RING.

N5. ALL NURSE CALL SYSTEM CONDUCTORS SHALL BE INSTALLED IN 3/4" MINIMUM SIZE COMPLETE CONDUIT SYSTEM TO ROOM CONTROLLER BOARD ABOVE CEILING AND THEN IN CABLE TRAY AND J-HOOKS TO NURSE CALL SWITCH AS INDICATED ON SHOP DRAWINGS PREPARED BY MANUFACTURER. PROVIDE ALL CONDUIT NECESSARY FOR NURSE CALL DEVICES SHOWN ON PLANS IN ACCORDANCE WITH WIRING DIAGRAMS AS PREPARED BY MANUFACTURER. COORDINATE EXACT LOCATION WITH ARCHITECTURAL ELEVATIONS. REFER TO SPECIFICATIONS FOR ADDITIONAL REQUIREMENTS.

### LOW VOLTAGE SYSTEM LEGEND



MASTER ANTENNA TELEVISION OUTLET (MATV) - CEILING MOUNTED OR WALL MOUNTED AT 12" BFC UNLESS OTHERWISE NOTED. PROVIDE 2 GANG FLUSH BOX WITH 1 GANG RAISED COVER WITH 1" CONDUIT TO ABOVE FINISHED CEILING - STUB AND BUSH. PROVIDE NEW MATV OUTLET TO MATCH EXISTING TYPE AND INSTALL (1) RG-6 COAX CABLE PER OUTLET TO EXISTING NETWORK CABLE TAP. CONNECT EACH CABLE AT OUTLET AND AT NETWORK CABLE TAP. SUPPORT CABLES USING 'J'-HOOKS 3'-0" ON CENTER OR EXISTING CABLE TRAY, WHERE AVAILABLE. TEST COMPLETE INSTALLATION IN ACCORDANCE WITH VA STANDARDS. COORDINATE WORK WITH VA ENGINEERING

CABLE TV DISTRIBUTION AMPLIFIER (MATCH EXISTING FACILITY TYPE) - WALL MOUNTED, CONNECT TO 120V-1Ø DUPLEX RECEPTACLE.

PUBLIC ADDRESS SPEAKER - CEILING MOUNTED.

#### LOW VOLTAGE SYSTEM NOTES:

- L1. REFER TO TECHNOLOGY DETAILS FOR ADDITIONAL INFORMATION.
- L2. REFER TO SPECIFICATIONS FOR ADDITIONAL REQUIREMENTS.
- L3. INTERCOM STATIONS SYSTEM EQUIPMENT AND WIRING SHALL BE PROVIDED BY CONTRACTOR. CONTRACTOR SHALL VERIFY ALL BACKBOX SIZES WITH VA COTR AND MANUFACTURER'S INSTALLATION INSTRUCTIONS PRIOR TO ROUGH-IN.
- L4. MOUNT DEVICES AT MOUNTING HEIGHTS LISTED ABOVE UNLESS OTHERWISE NOTED ON THE FLOOR PLANS. COORDINATE EXACT MOUNTING LOCATION WITH ARCHITECTURAL ELEVATIONS.

#### SECURITY SYSTEM LEGEND

LENEL SECURITY CONTROL PANEL. REFER TO SECURITY SYSTEM RISER AND DETAILS FOR ADDITIONAL INFORMATION AND WORK REQUIREMENTS

- SECURITY SYSTEM NOTES:
- S1. PROVIDE MINIMUM SIZE BACKBOX AS REQUIRED FOR ALL OF THE ABOVE SECURITY DEVICES AND INSTALL IN 1/2"C MINIMUM COMPLETE CONDUIT SYSTEM TO JUNCTION BOX ABOVE FINISHED CEILING. REFER TO THE "ACCESS-CONTROLLED DOOR DETAIL" ON THE TECHNOLOGY DETAILS DRAWING FOR ADDITIONAL INFORMATION.
- S2. REFER TO SPECIFICATIONS DIVISION 28 FOR FURTHER DETAILS REGARDING THE SECURITY SYSTEM.
- S3. MOUNT DEVICES AT MOUNTING HEIGHTS LISTED ABOVE UNLESS OTHERWISE NOTED ON THE FLOOR PLANS. COORDINATE EXACT MOUNTING LOCATION WITH ARCHITECTURAL ELEVATIONS.
- S4. SECURITY SYSTEM CONDUIT AND NECESSARY SYSTEM WIRING SHALL BE PROVIDED BY CONTRACTOR. SECURITY SYSTEM EQUIPMENT SHALL BE FURNISHED AND INSTALLED BY OWNER.
- S5. CONTRACTOR SHALL VERIFY ALL BACKBOX SIZES WITH VA COTR AND MANUFACTURER'S INSTALLATION INSTRUCTIONS PRIOR TO ROUGH-IN.
- S6. FURNISH, INSTALL AND CONNECT ALL SECURITY DEVICES IN ACCORDANCE WITH LENEL SYSTEM PROVIDER. PROVIDE ALL ADDITIONAL LENEL
- COMPONENTS AS NECESSARY FOR A COMPLETE SYSTEM. SUBMIT ALL LENEL DEVICES WITH SHOP DRAWINGS SUBMITTAL.

#### GENERAL LEGEND



CODED NOTE - "1" INDICATES NOTE NUMBER.



1-SF MECHANICAL EQUIPMENT IDENTIFIER



DETAIL REFERENCE - "1" INDICATES DETAIL NUMBER, "1-E01" INDICATED DRAWINGS NUMBER



COLUMN GRID



REVISION REFERENCE NUMBER

#### GENERAL TECHNOLOGY INSTALLATION NOTES:

- 1. ALL MOUNTING HEIGHTS ARE TO CENTER OF DEVICE UNLESS OTHERWISE NOTED.
- 2. ALL NEW WALL MOUNTED TECHNOLOGY DEVICES ARE TO BE INSTALLED FLUSH IN WALL UNLESS OTHERWISE NOTED. ALL CONDUIT SHALL BE CONCEALED BEHIND FINISHED WALLS AND ABOVE FINISHED CEILING UNLESS OTHERWISE NOTED. THE COST TO CUT AND PATCH WALLS SHALL BE THE RESPONSIBILITY OF THE TRADE REQUIRING THE CUTTING.
- CONTRACTOR IS RESPONSIBLE FOR REMOVAL AND REPLACEMENT OF CEILINGS REQUIRED FOR ELECTRICAL WORK. CONTRACTOR SHALL REPLACE ANY DAMAGED CEILING TILES.
- 4. PRIOR TO INSTALLATION, VERIFY PRECISE LOCATION OF NEW OR RELOCATED WALL OR CEILING MOUNTED DEVICES WITH ARCHITECTURAL ELEVATIONS AND REFLECTED CEILING PLANS.
- 5. COORDINATE ALL SHUT-DOWNS OF EXISTING ELECTRICAL SYSTEMS WITH OWNER A MINIMUM OF FOURTEEN (14) WORKING DAYS IN ADVANCE. ALL SHUT-DOWNS SHALL OCCUR DURING WEEKENDS OR BETWEEN 8:00PM AND 7:00AM ON WEEKDAYS ("OFF-HOURS"). INCLUDE ALL PREMIUM TIME CHARGES
- 6. ALL NOISE GENERATING OPERATIONS, INCLUDING CUTTING OF CEILINGS, WALLS AND FLOORS, CORING, DRILLING, ETC. SHALL BE SCHEDULED DURING
- WEEKENDS OR BETWEEN 8:00PM AND 7:00AM ON WEEKDAYS ("OFF-HOURS"). INCLUDE ALL PREMIUM TIME CHARGES IN BID.
- CONTRACTOR SHALL CONNECT ALL MECHANICAL EQUIPMENT COMPLETE PER MANUFACTURER'S WIRING DIAGRAMS AND INSTRUCTIONS. COORDINATE WITH MECHANICAL CONTRACTOR AND VERIFY LOCATION, VOLTAGE, AMPS, NO. OF WIRES, AND PROTECTION REQUIREMENTS PRIOR TO ROUGH-IN. CONTACT ENGINEER WITH ANY DISCREPANCIES FROM DESIGN DRAWINGS.
- 8. PROVIDE LIQUID-TIGHT FLEXIBLE METAL CONDUIT FOR FINAL CONNECTION TO MECHANICAL EQUIPMENT OR OTHER EQUIPMENT WHICH MAY PROPAGATE
- 9. ALL FLUORESCENT LAMPS THAT WILL NOT BE REUSED SHALL BE DISPOSED OF IN ACCORDANCE WITH EPA STANDARDS, AND WRITTEN EVIDENCE OF PROPER DISPOSAL SHALL BE FURNISHED TO THE OWNER.
- 10. ALL WORK SHALL BE PERFORMED IN STRICT CONFORMANCE WITH THE PHASING REQUIREMENTS OF THE PROJECT. ALL COSTS ASSOCIATED WITH THESE REQUIREMENTS SHALL BE INCLUDED IN THE BID SUBMITTAL.
- 11. CONTRACTOR IS RESPONSIBLE FOR PROVIDING TEMPORARY LIGHTING TO ADEQUATELY LIGHT ALL CONSTRUCTION AREAS. TEMPORARILY PARTITIONED
- AREAS, AND EXIT CORRIDORS MAINTAINED DURING CONSTRUCTION. 12. <u>DEFINITION:</u> "PROVIDE" - FURNISH, INSTALL AND CONNECT COMPLETE.
- 13. PROJECT AND PHASING SCOPE LINES INDICATE WHERE GENERAL CONSTRUCTION BOUNDERIES OCCUR. ELECTRICAL WORK AND UTILITY TIE-INS MAY OCCUR OUTSIDE OF SCOPE LINES.

### **ABBREVIATIONS**

ABOVE COUNTER AT 9" UNLESS OTHERWISE NOTED ABOVE FINISHED CEILING

AUTOMATIC TRANSFER SWITCH ABOVE FINISHED FLOOR ATS

CEILING MOUNTED

CONTRACTING OFFICER'S REPRESENTATIVE

ELECTRICAL CONTRACTOR

EOL END OF LINE ELECTRIC WATER COOLER

GENERAL CONTRACTOR

GROUND FAULT CIRCUIT INTERRUPTER INFORMATION RESOURCES MANAGEMENT ISOLATED GROUND

MECHANICAL CONTRACTOR

MCB MAIN CIRCUIT BREAKER

MAIN LUGS ONLY

SURFACE MOUNTED TCC TEMPERATURE CONTROLS CONTRACTOR

NATIONAL ELECTRICAL CODE

VARIABLE SPEED MOTOR CONTROLLER

EQUIPMENT GROUND

TELEVISION WEATHERPROOF ENCLOSURE - NEMA 4 TYPE

TELECOMMUNICATIONS CONTRACTOR

- EXISTING OUTLET, DEVICE, LIGHTING FIXTURE, CONDUIT, ETC. TO REMAIN
- INDICATES EXISTING OUTLET, LIGHTING FIXTURE, CONDUIT, ETC TO BE REMOVED. PROVIDE BLANK COVER FOR OUTLET AND MAINTAIN CIRCUIT CONTINUITY.
- NEW LOCATION OF EXISTING OUTLET, DEVICE, LIGHTING FIXTURE, ETC.
- EXISTING OUTLET, DEVICE, LIGHTING FIXTURE, ETC. TO BE REPLACED WITH NEW OF SPECIFIED TYPE
- EXISTING OUTLET, DEVICE, LIGHTING FIXTURE, CONDUIT, ETC. TO BE REMOVED COMPLETE- MAINTAIN CIRCUIT CONTINUITY TO ADJACENT OUTLETS, EXTEND CONDUIT AND WIRING AS REQUIRED.
- EXISTING OUTLET, DEVICE, LIGHTING FIXTURE, ETC. TO BE REMOVED AND REINSTALLED AT NEW LOCATION EXTEND CONDUIT AND
- EXISTING CEILING DEVICE, LIGHTING FIXTURE, ETC. TO BE REMOVED AND REINSTALLED AT SAME LOCATION
- VAMC VETERANS AFFAIRS MEDICAL CENTER

### **FULLY SPRINKLERED**

Project Number

### **CONSULTANTS:**



02/23/15

Date

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VA FORM 08-6231, OCT 1978

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TECHNOLOGY LEGEND **SCI OUTPATIENT CLINIC** 541-CSI-102 **ADDITION Building Number Drawing Number** Approved: **VAMC - WADE PARK** 1-**T**0.1 Checked 02/23/15 MPL TWM Dwg.


Project Title

Department of **Veterans Affairs** 

Office of

**Facilities** 

Management

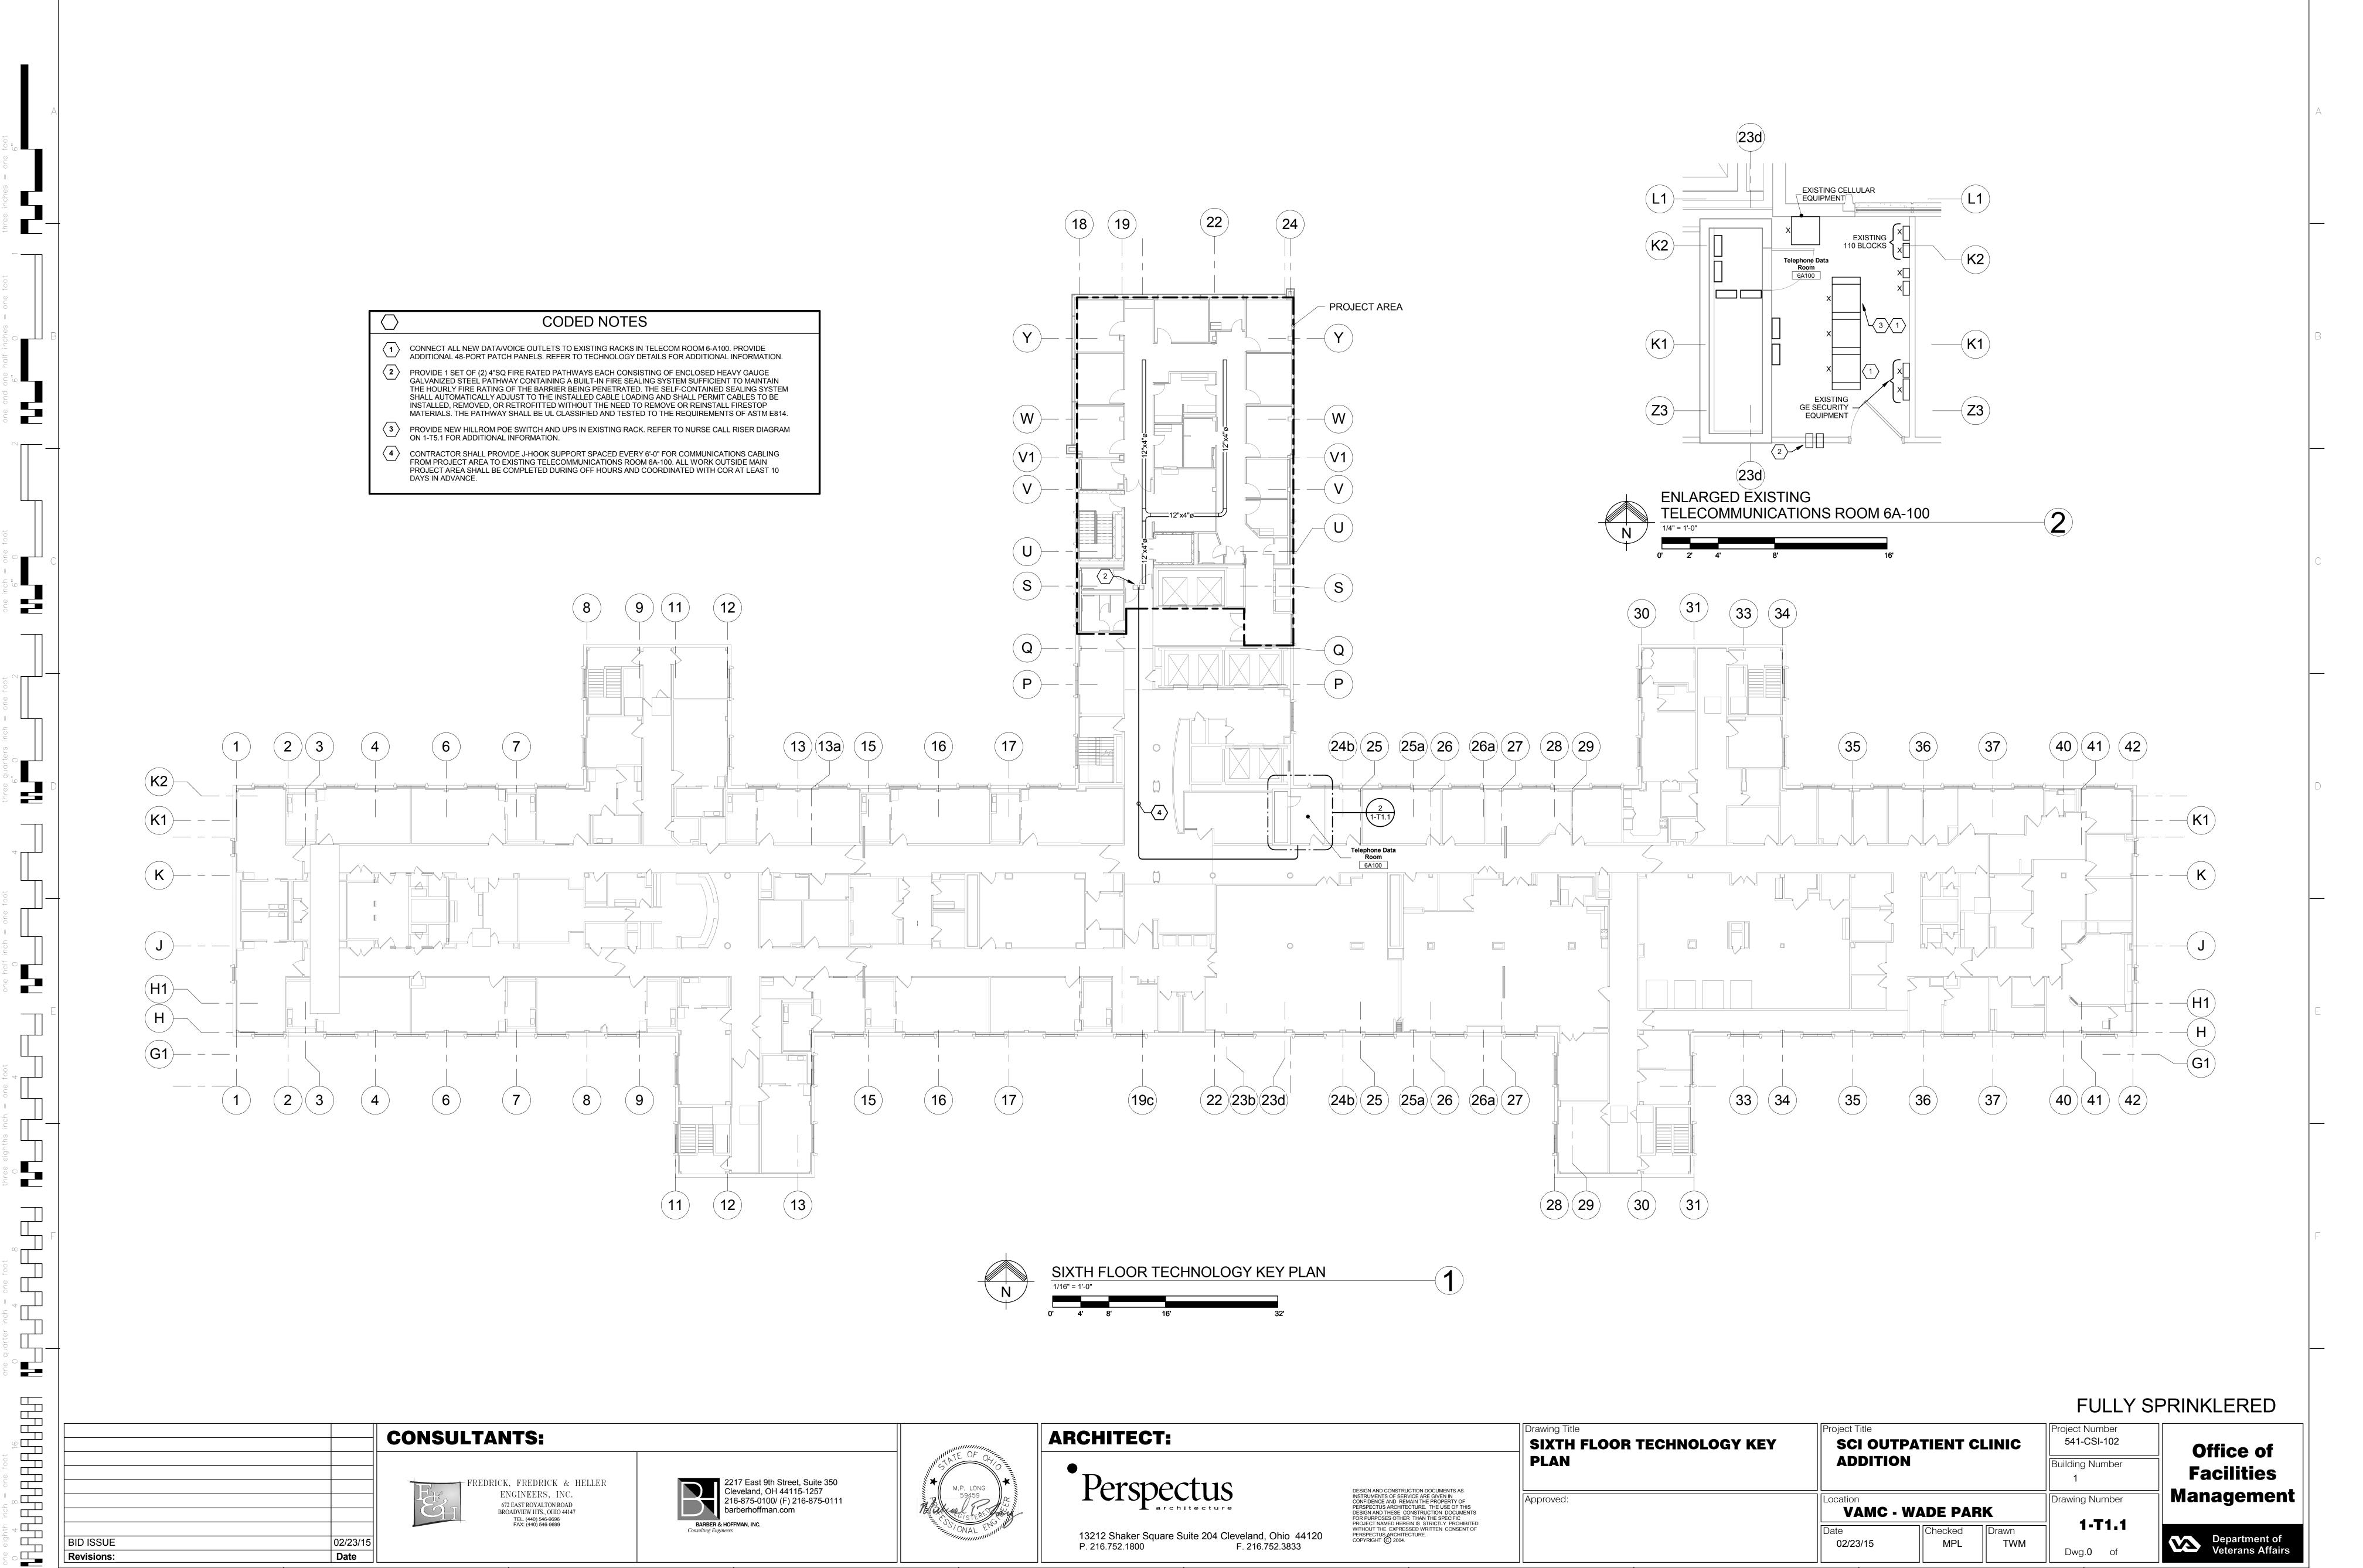


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VA FORM 08-6231, OCT 1978

**Revisions:** 

Date

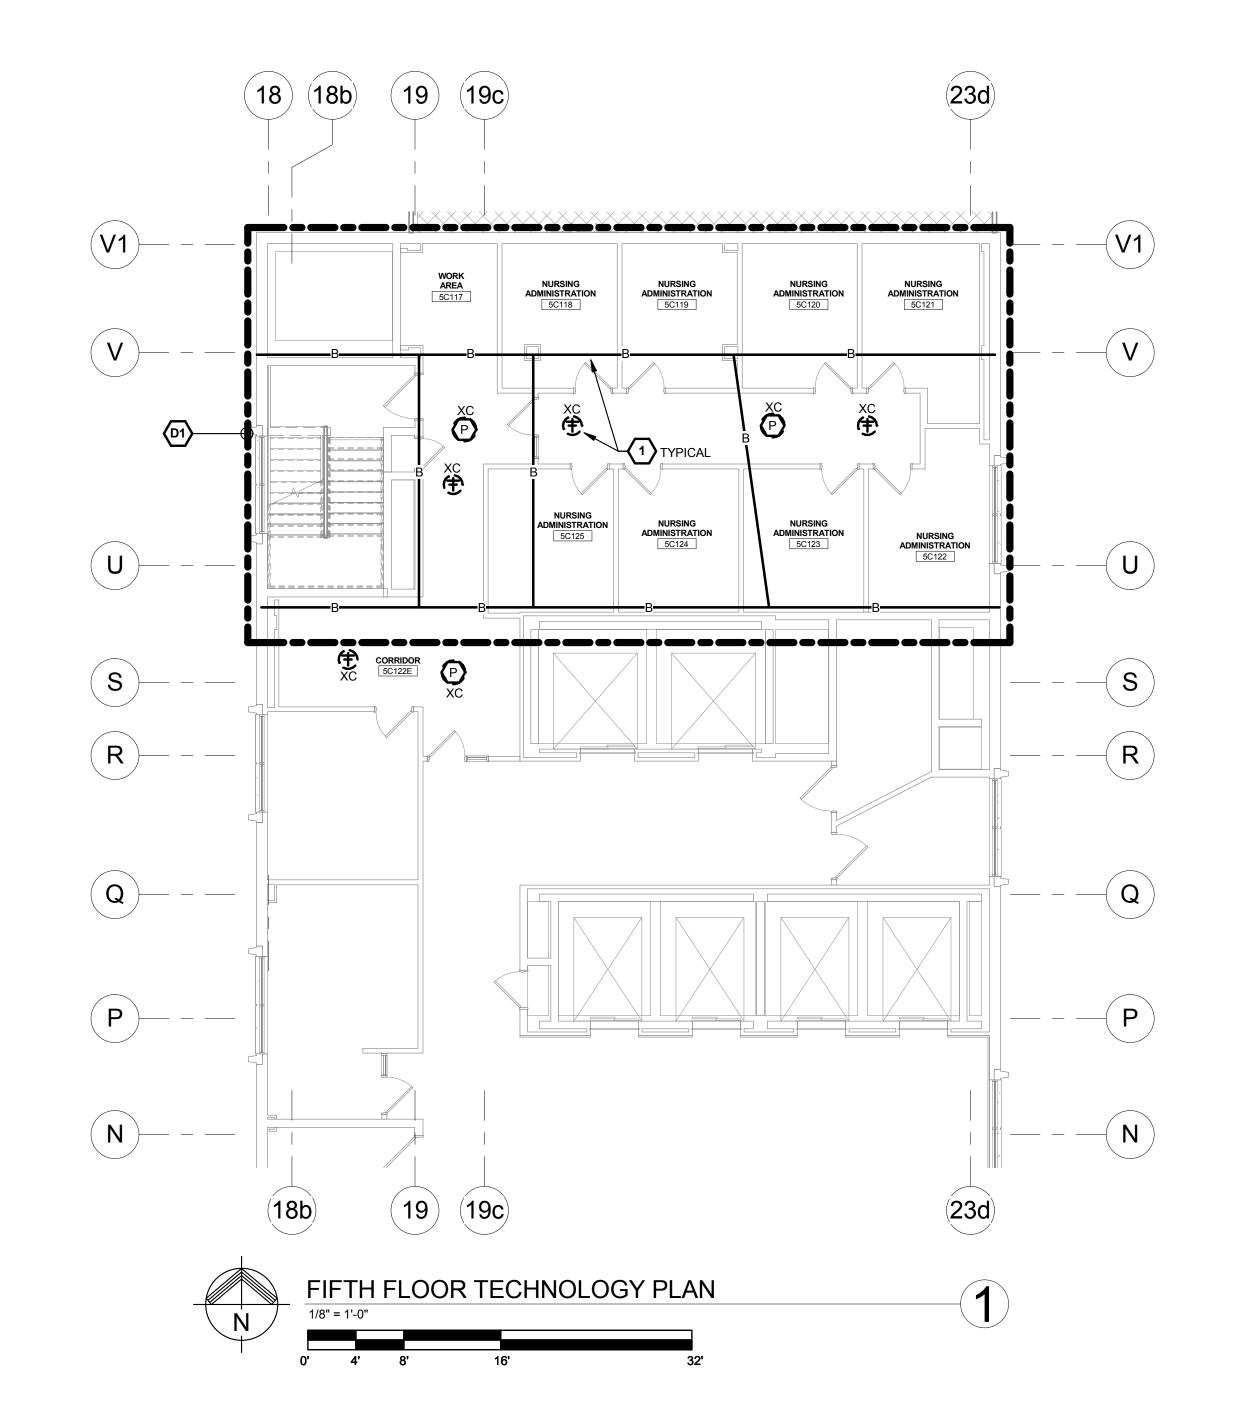

#### TECHNOLOGY DEMOLITION NOTES

- D1 ALL EXISTING SPECIAL SYSTEMS OUTLETS, CONDUIT, WIRING ETC. THAT WILL NOT BE REUSED IN THE REMODELED INSTALLATION SHALL BE REMOVED UNLESS OTHERWISE NOTED. THIS DEMOLITION SHALL INCLUDE ALL ELECTRICAL ITEMS SHOWN ON THIS PLAN THAT ARE DESIGNATED BY "XR" OR "XB" AND ALL OTHER ADDITIONAL ITEMS THAT ARE NOT SHOWN BUT THAT MUST BE REMOVED IN ORDER TO PRODUCE A NEAT, FINISHED, PROPERLY FUNCTIONING ELECTRICAL INSTALLATION. MAINTAIN CIRCUIT CONTINUITY TO ALL EXISTING REUSED ELECTRICAL SYSTEMS COMPONENTS - PROVIDE ALL CONDUIT AND WIRING NECESSARY TO ACHIEVE THE SAME. THE CONTRACTOR SHALL FIELD VERIFY THE NATURE AND EXTENT OF ALL DEMOLITION WORK AND SHALL INCLUDE COST FOR THE SAME IN THE BID SUBMITTAL.
- D2 ALL EXISTING REMOVED TECHNOLOGY EQUIPMENT, DEVICES, ETC. THAT ARE NOT RETAINED BY THE OWNER SHALL BE DISPOSED OF BY THE ELECTRICAL CONTRACTOR. D3 DASHED WALLS ON PLAN INDICATE EXISTING CONSTRUCTION TO BE REMOVED.
- D4 REFER TO TECHNOLOGY LEGEND FOR ALL SYMBOL DESIGNATIONS. NOTE SPECIAL ATTENTION TO SELECTED EXISTING DEVICES, WIREWAYS, ETC. MARKED XB, XRR OR XN, AND REMOVE/BLANK OFF, RELOCATE OR REPLACE THESE COMPONENTS AS REQUIRED.
- D5 MAINTAIN CIRCUIT CONTINUITY TO ALL EXISTING TECHNOLOGY SYSTEM COMPONENTS IN AREAS NOT BEING REMODELED UNLESS OTHERWISE NOTED. PROVIDE ALL CONDUIT AND WIRING EXTENSIONS NECESSARY TO
- D6 THE ELECTRICAL CONTRACTOR SHALL CLOSELY COORDINATE ALL TECHNOLOGY DEMOLITION WORK WITH THE GENERAL AND MECHANICAL CONTRACTORS.

**DEDUCT ALTERNATE 2:** 

UPON THE ACCEPTANCE OF DEDUCT ALTERNATE 2:


DELETE THE WORK ASSOCIATED WITH REINSTALLING CEILING MOUNTED DEVICES INCLUDING LIGHTING FIXTURES, SMOKE DETECTORS, WIRELESS ACCESS POINTS, PAGING SPEAKERS, FOLLOWING COMPLETION OF STRUCTURAL WORK.

TECHNOLOGY CODED NOTES

APPROXIMATE LOCATION OF NEW STRUCTURAL BEAMS AND REINFORCEMENTS. REMOVE ALL CEILING MOUNTED DEVICES INCLUDING LIGHTING FIXTURES, SMOKE DETECTORS, WIRELESS ACCESS POINTS, AND PAGING SPEAKERS. REINSTALL DEVICES AT SAME LOCATION FOLLOWING STRUCTURAL WORK.


**FULLY SPRINKLERED** 

Project Title Project Number Drawing Title **CONSULTANTS: ARCHITECT:** 541-CSI-102 FIFTH FLOOR TECHNOLOGY PLAN SCI OUTPATIENT CLINIC Office of **ADDITION** Building Number **Facilities** 2217 East 9th Street, Suite 350 Cleveland, OH 44115-1257 216-875-0100/ (F) 216-875-0111 FREDRICK, FREDRICK & HELLER DESIGN AND CONSTRUCTION DOCUMENTS AS INSTRUMENTS OF SERVICE ARE GIVEN IN CONFIDENCE AND REMAIN THE PROPERTY OF PERSPECTUS ARCHITECTURE. THE USE OF THIS DESIGN AND THESE CONSTRUCTION DOCUMENTS FOR PURPOSES OTHER THAN THE SPECIFIC PROJECT NAMED HEREIN IS STRICTLY PROHIBITED WITHOUT THE EXPRESSED WRITTEN CONSENT OF PERSPECTUS ARCHITECTURE. COPYRIGHT © 2004. Management ENGINEERS, INC. Drawing Number Approved: 672 EAST ROYALTON ROAD **VAMC - WADE PARK** barberhoffman.com BROADVIEW HTS., OHIO 44147 TEL. (440) 546-9696 FAX: (440) 546-9699 1-T2.1 BARBER & HOFFMAN, INC. Drawn Checked 13212 Shaker Square Suite 204 Cleveland, Ohio 44120 Department of Veterans Affairs BID ISSUE 02/23/15 TWM MPL P. 216.752.1800 F. 216.752.3833 Dwg.0 of Date **Revisions:** 

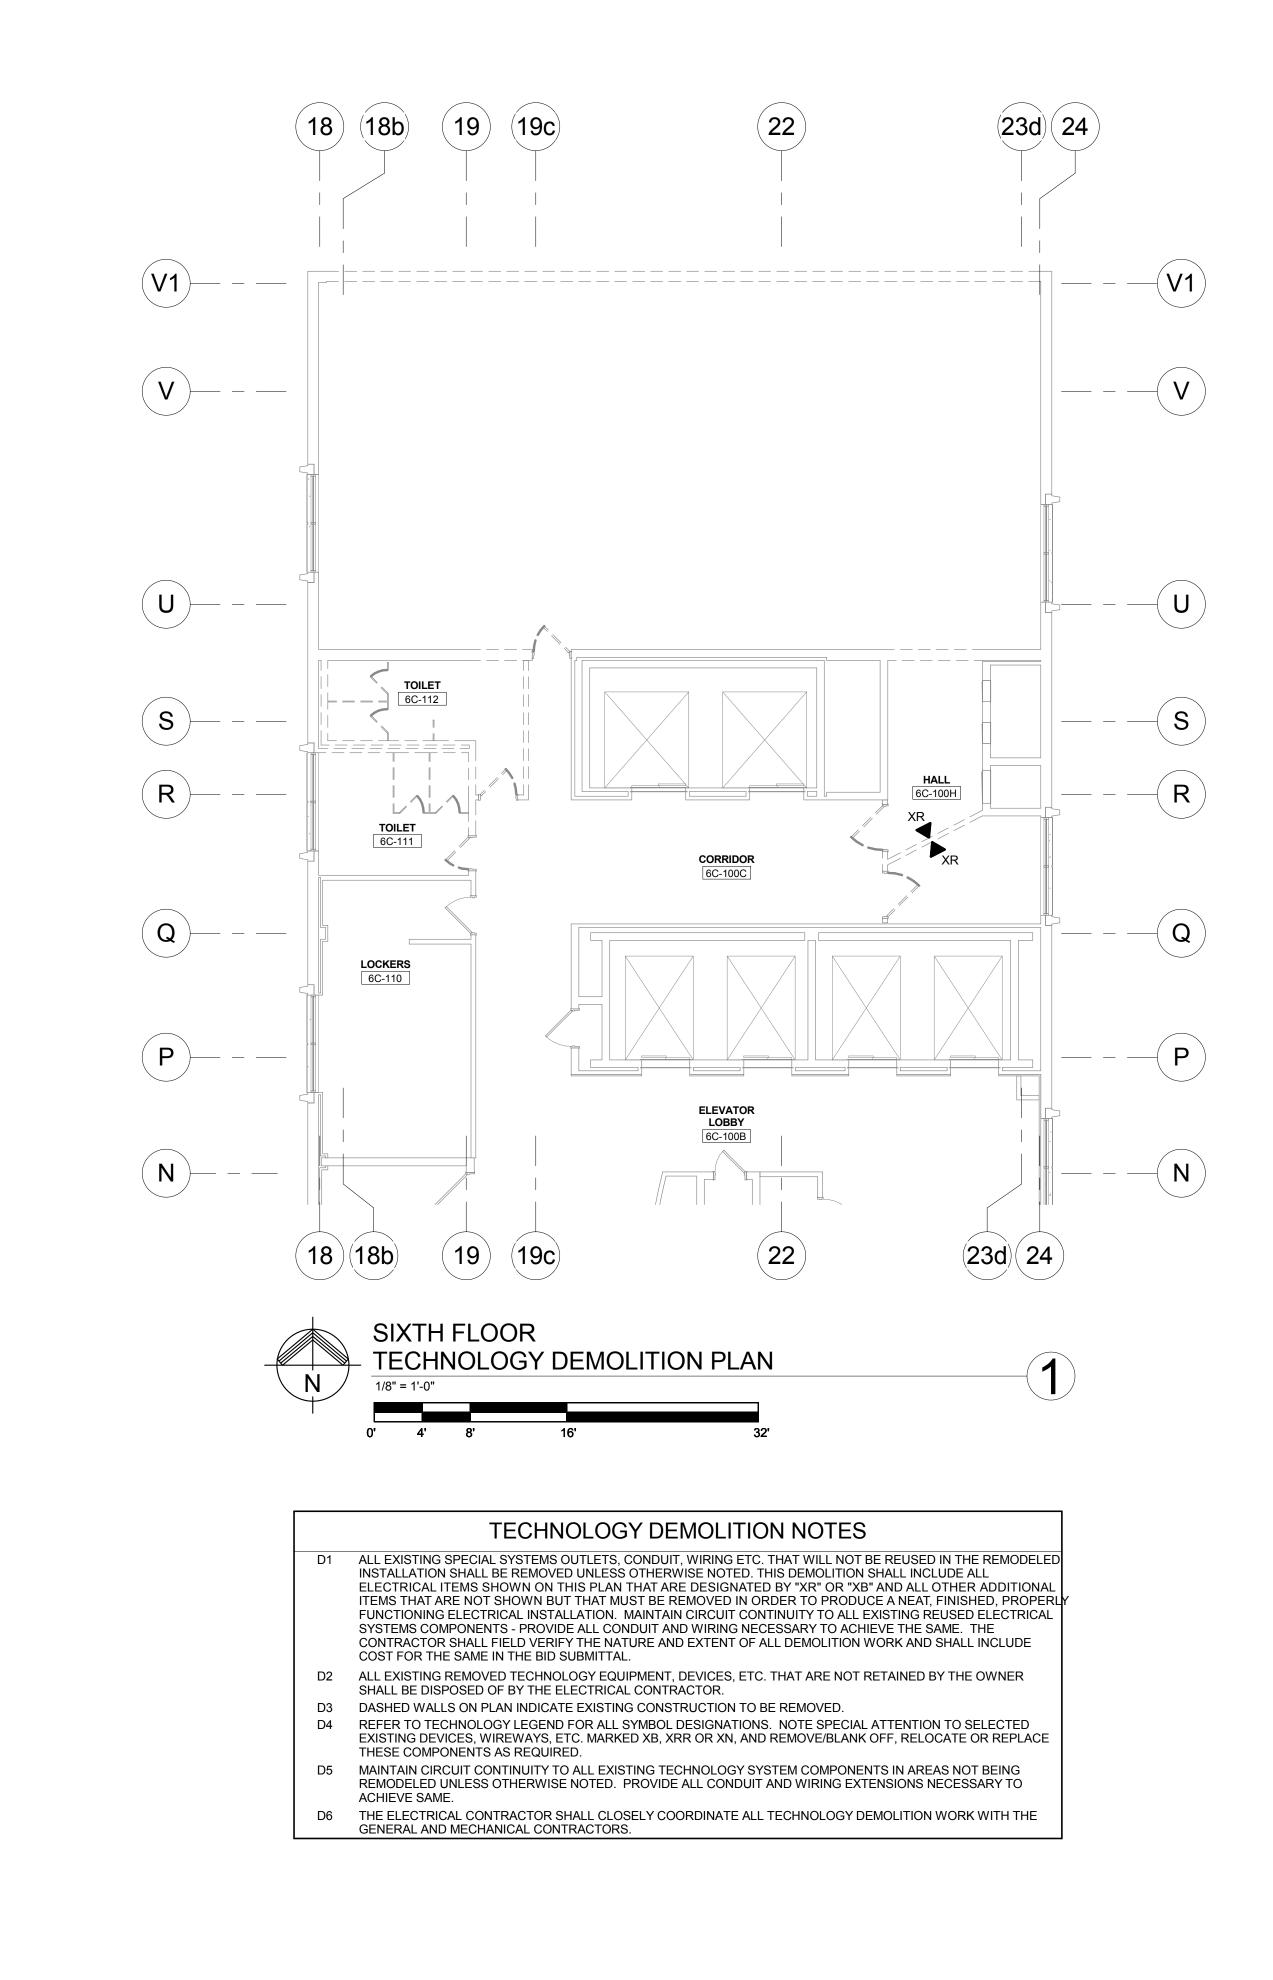

#### **FULLY SPRINKLERED** Project Number Drawing Title Project Title **CONSULTANTS: ARCHITECT:** 541-CSI-102 SIXTH FLOOR TECHNOLOGY SCI OUTPATIENT CLINIC Office of **DEMOLITION PLAN ADDITION** Building Number **Facilities** 2217 East 9th Street, Suite 350 Cleveland, OH 44115-1257 216-875-0100/ (F) 216-875-0111 barberhoffman.com FREDRICK, FREDRICK & HELLER DESIGN AND CONSTRUCTION DOCUMENTS AS INSTRUMENTS OF SERVICE ARE GIVEN IN CONFIDENCE AND REMAIN THE PROPERTY OF PERSPECTUS ARCHITECTURE. THE USE OF THIS DESIGN AND THESE CONSTRUCTION DOCUMENTS FOR PURPOSES OTHER THAN THE SPECIFIC PROJECT NAMED HEREIN IS STRICTLY PROHIBITED WITHOUT THE EXPRESSED WRITTEN CONSENT OF PERSPECTUS ARCHITECTURE. COPYRIGHT © 2004. Management ENGINEERS, INC. Drawing Number Approved: 672 EAST ROYALTON ROAD **VAMC - WADE PARK** BROADVIEW HTS., OHIO 44147 TEL. (440) 546-9696 FAX: (440) 546-9699 1-T2.2 BARBER & HOFFMAN, INC. Drawn Checked 13212 Shaker Square Suite 204 Cleveland, Ohio 44120 P. 216.752.1800 F. 216.752.3833 Department of Veterans Affairs BID ISSUE 02/23/15 TWM MPL Dwg.0 of Date


**Revisions:** 

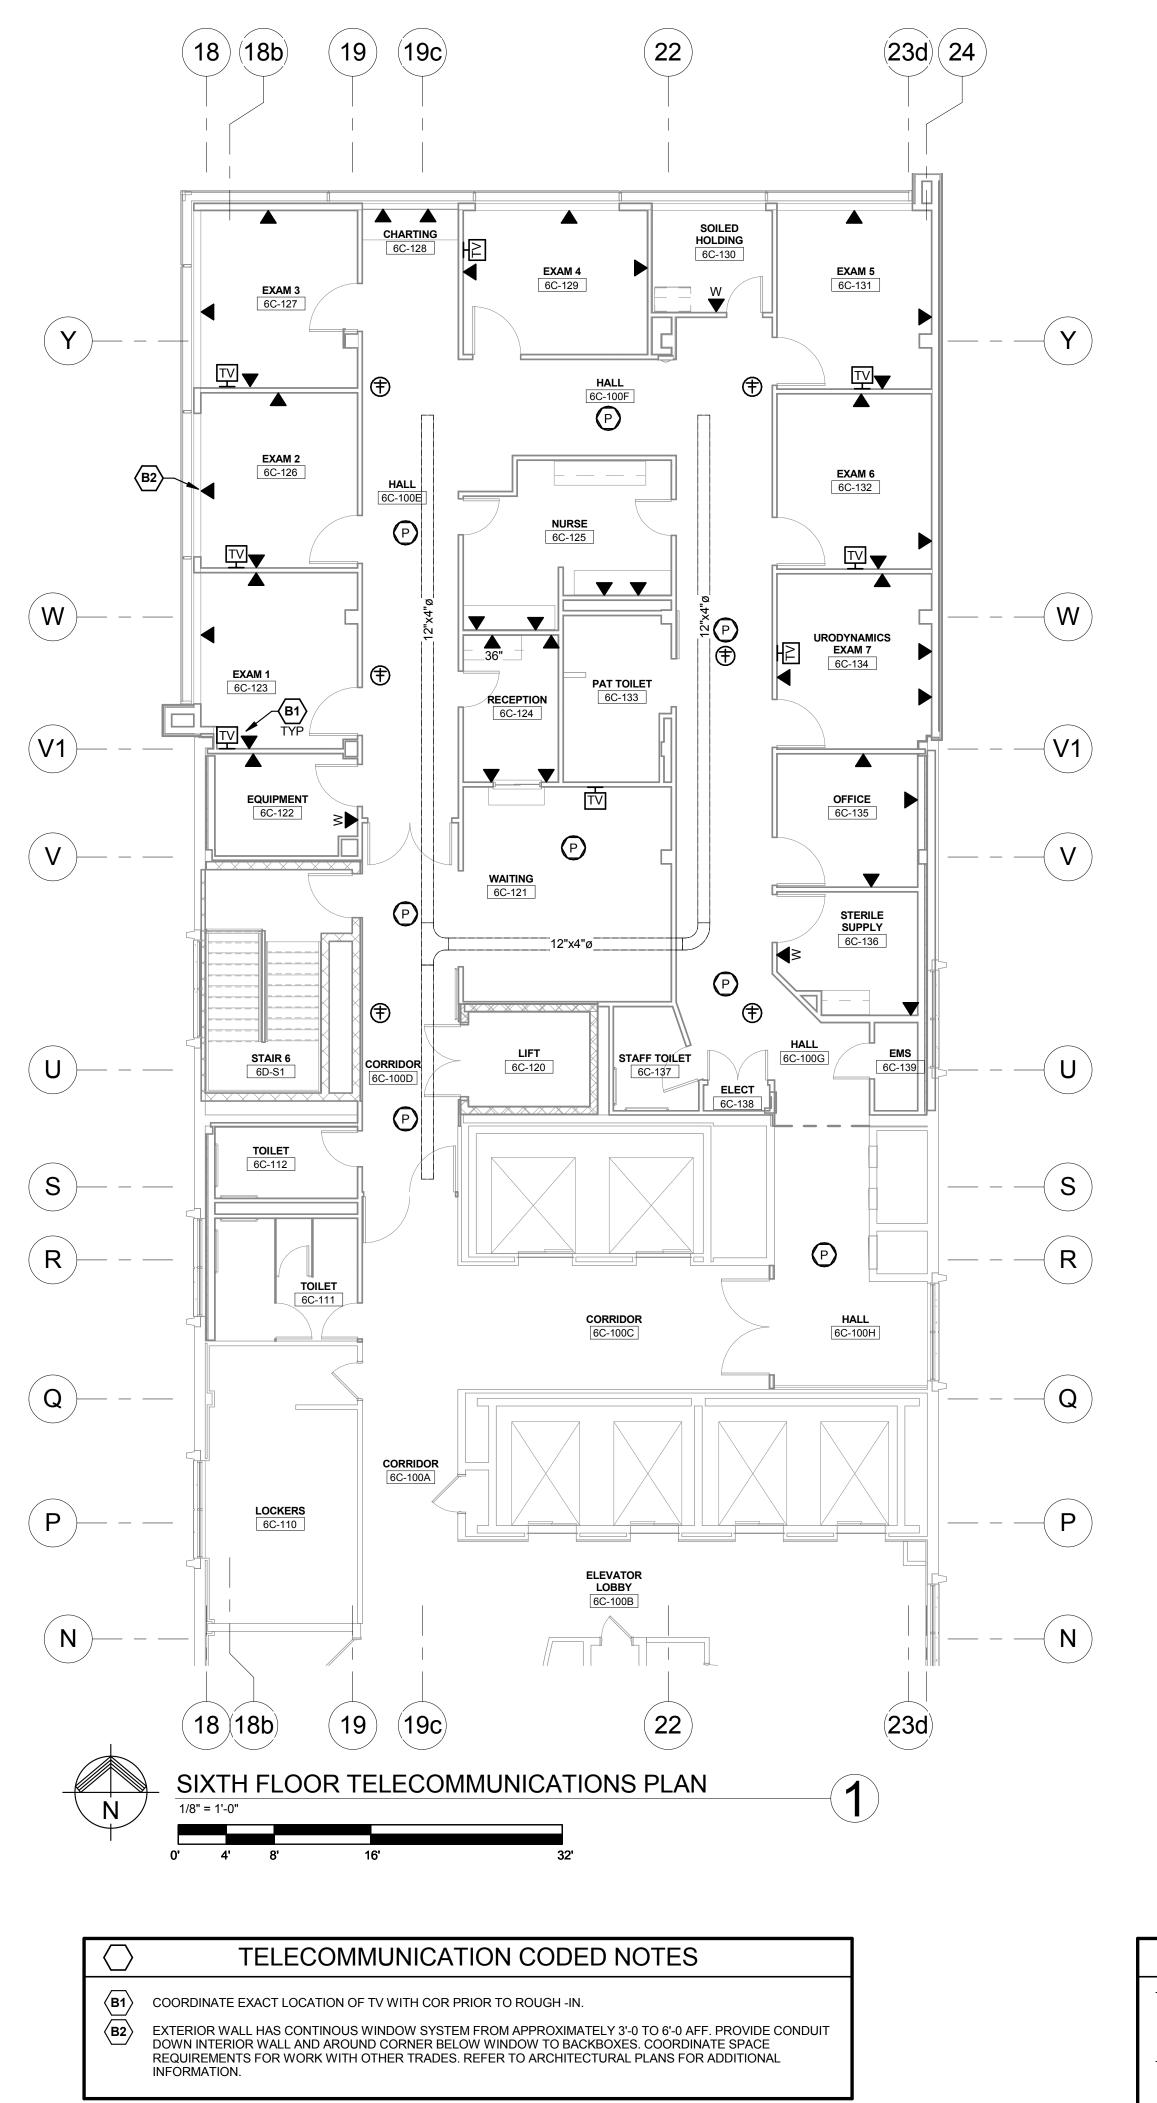

VA FORM 08-6231. OCT 1978



- 1. REFER TO THE ARCHITECTURAL PLANS FOR EQUIPMENT LAYOUT. CLOSELY COORDINATE THE EXACT LOCATION OF ALL OUTLETS AND DEVICES WITH ARCHITECTURAL ELEVATIONS. ADJUST LOCATIONS AND MOUNTING HEIGHTS WHERE NECESSARY TO PREVENT INTERFERENCE WITH FURNITURE, FIXED CASEWORK, EQUIPMENT, ETC. VERIFY ALL CHANGES PRIOR TO ROUGH-IN.
- T2. CONTRACTOR SHALL VERIFY ALL EQUIPMENT LOCATIONS, MOUNTING HEIGHTS, AND CONNECTION REQUIREMENTS (DATA OUTLETS, ETC) WITH EQUIPMENT VENDOR PRIOR TO ROUGH-IN.
- T3. ALL NEW TECHNOLOGY UNTILITIES IN CORRIDORS SHALL BE ROUTED AS HIGH AS POSSIBLE.
- T4. REFER TO ARCHITECTURAL PLANS FOR EXACT PHASING AND ALTERNATE REQUIREMENTS
- T5. REFER TO "SIXTH FLOOR TECHNOLOGY KEY PLAN" FOR ADDITIONAL INFORMATION.

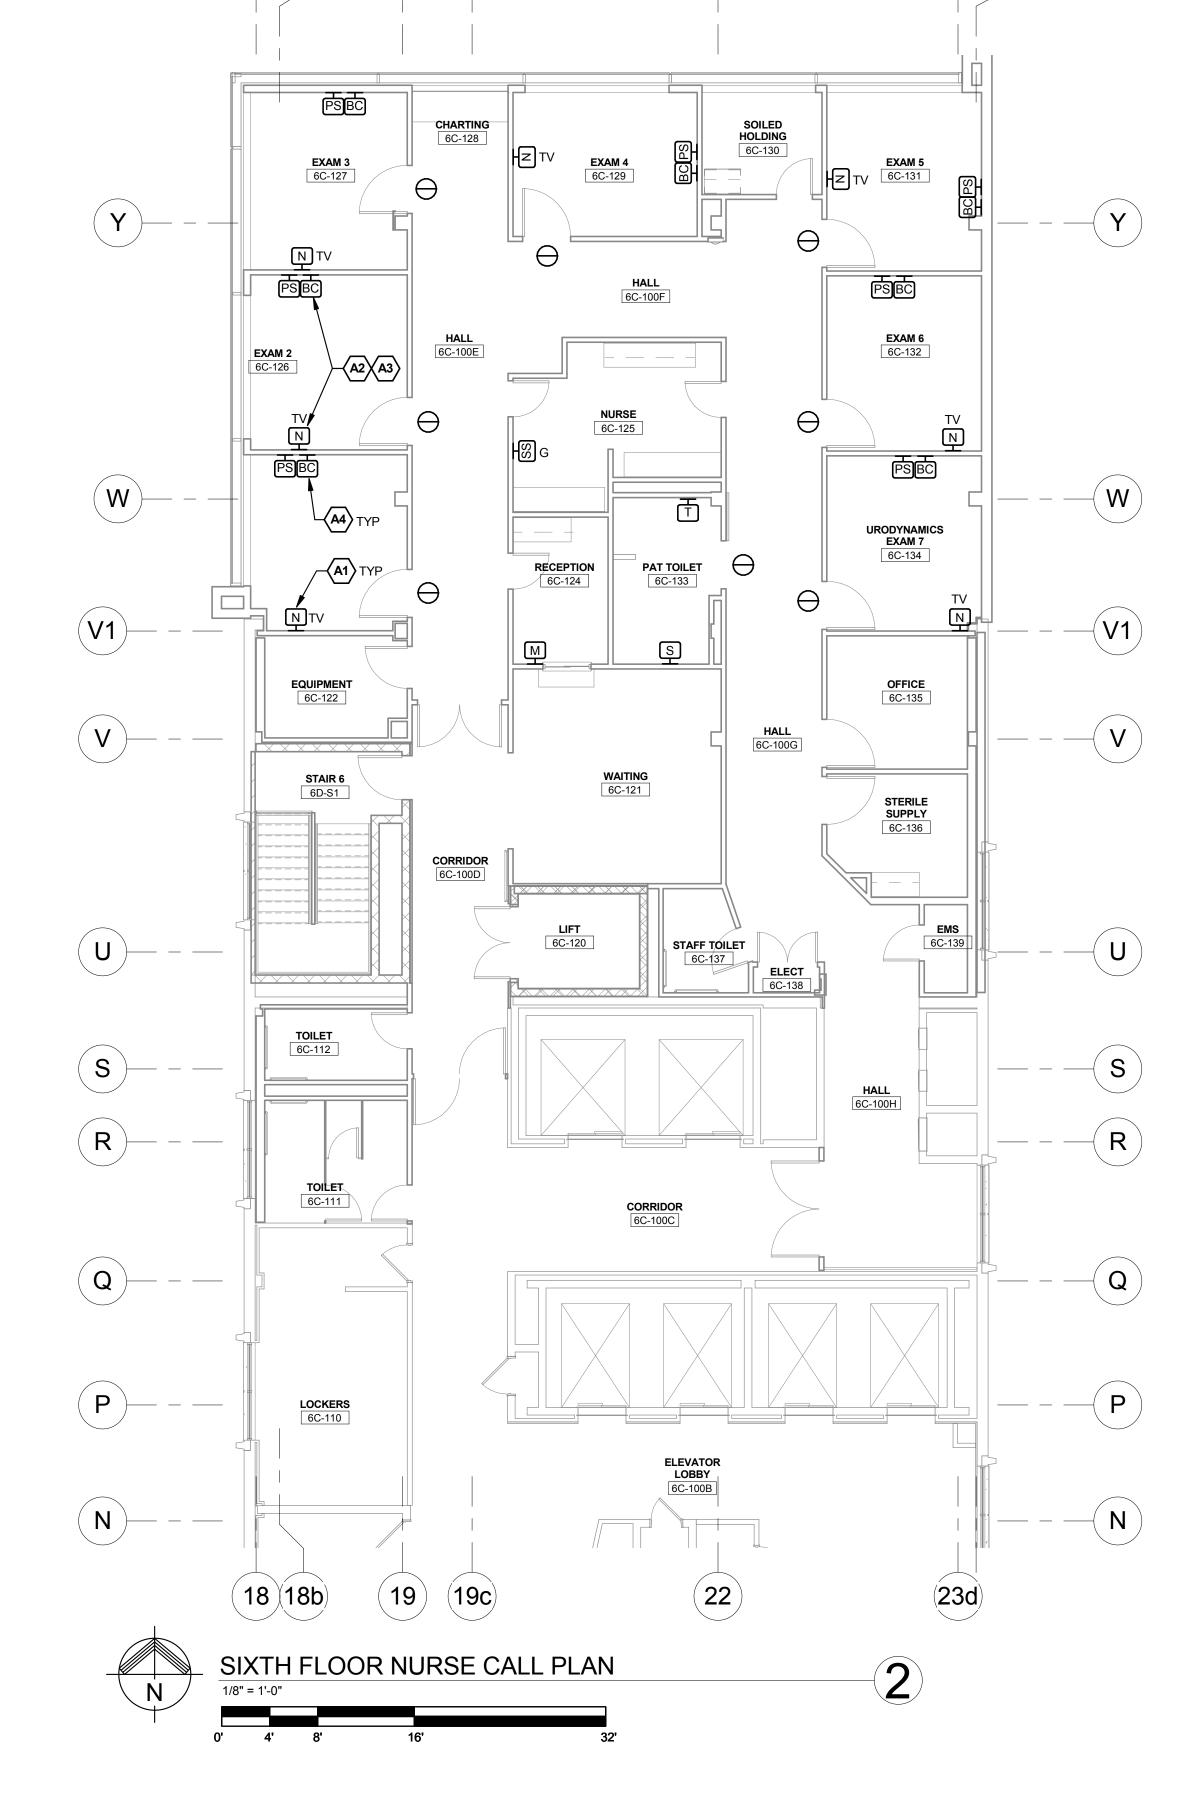


(23d) (24)


# NURSE CALL CODED NOTES

- (A1) COORDINATE EXACT LOCATION OF NURSE CALL FOR TV WITH COR PRIOR TO ROUGH -IN.
- PROVIDE 18/6 CABLE FROM HILL-ROM AUDIO STATION BED CONNECTOR TO TV INTERFACE. NOTE THAT ONLY 3 CONDUCTORS ARE TO BE UTILIZED. COORDINATE EXACT WIRING TERMINATION REQUIREMENTS WITH HILL-ROM, PILLOW SPEAKER MANUFACTURER AND TELEVISION MANUFACTURER.
- PROVIDE 1/4" TRS MALE TO 1/4" TRS MALE PATCH CABLE FROM NURSE CALL JACK TO OWNER PROVIDED TELEVISION, COORDINATE WITH COR PRIOR TO ORDERING. TELEVISION. COORDINATE WITH COR PRIOR TO ORDERING.
- PROVIDE DIGITAL PILLOW SPEAKER FOR EACH EXAM ROOM (7 TOTAL) CAPABLE OF BEING PROGRAMMED FOR VA PROVIDED HOSPITAL GRADE TELEVISION. PILLOW SPEAKER SHALL HAVE THE FOLLOWING FEATURES: 1) DIRECT CHANNEL ENTRY (0-10 KEYPAD) 2) HILL-ROM BED CONTROLLER OUTLET COMPATIBLE CONNECTOR 3) DIGITAL VOLUME AND CHANNEL CONTROLS 4) FIELD REPROGRAMMABLE FOR DIFFERENT TELEVISION BRANDS

## **FULLY SPRINKLERED**

8 4 9 Drawing Title Project Title Project Number **ARCHITECT: CONSULTANTS:** 541-CSI-102 SCI OUTPATIENT CLINIC SIXTH FLOOR Office of TELECOMMUNICATIONS AND **ADDITION** Building Number **Facilities** NURSE CALL PLAN 2217 East 9th Street, Suite 350 Cleveland, OH 44115-1257 FREDRICK, FREDRICK & HELLER Management DESIGN AND CONSTRUCTION DOCUMENTS AS INSTRUMENTS OF SERVICE ARE GIVEN IN CONFIDENCE AND REMAIN THE PROPERTY OF PERSPECTUS ARCHITECTURE. THE USE OF THIS DESIGN AND THESE CONSTRUCTION DOCUMENTS FOR PURPOSES OTHER THAN THE SPECIFIC PROJECT NAMED HEREIN IS STRICTLY PROHIBITED WITHOUT THE EXPRESSED WRITTEN CONSENT OF PERSPECTUS ARCHITECTURE. COPYRIGHT © 2004. ENGINEERS, INC. Drawing Number 216-875-0100/ (F) 216-875-0111 Approved: 672 EAST ROYALTON ROAD **VAMC - WADE PARK** barberhoffman.com BROADVIEW HTS., OHIO 44147 TEL. (440) 546-9696 FAX: (440) 546-9699 1-T3.1 BARBER & HOFFMAN, INC. Checked Drawn 13212 Shaker Square Suite 204 Cleveland, Ohio 44120 Department of Veterans Affairs BID ISSUE TWM MPL 02/23/15 P. 216.752.1800 F. 216.752.3833 Dwg.0 of Date **Revisions:** 

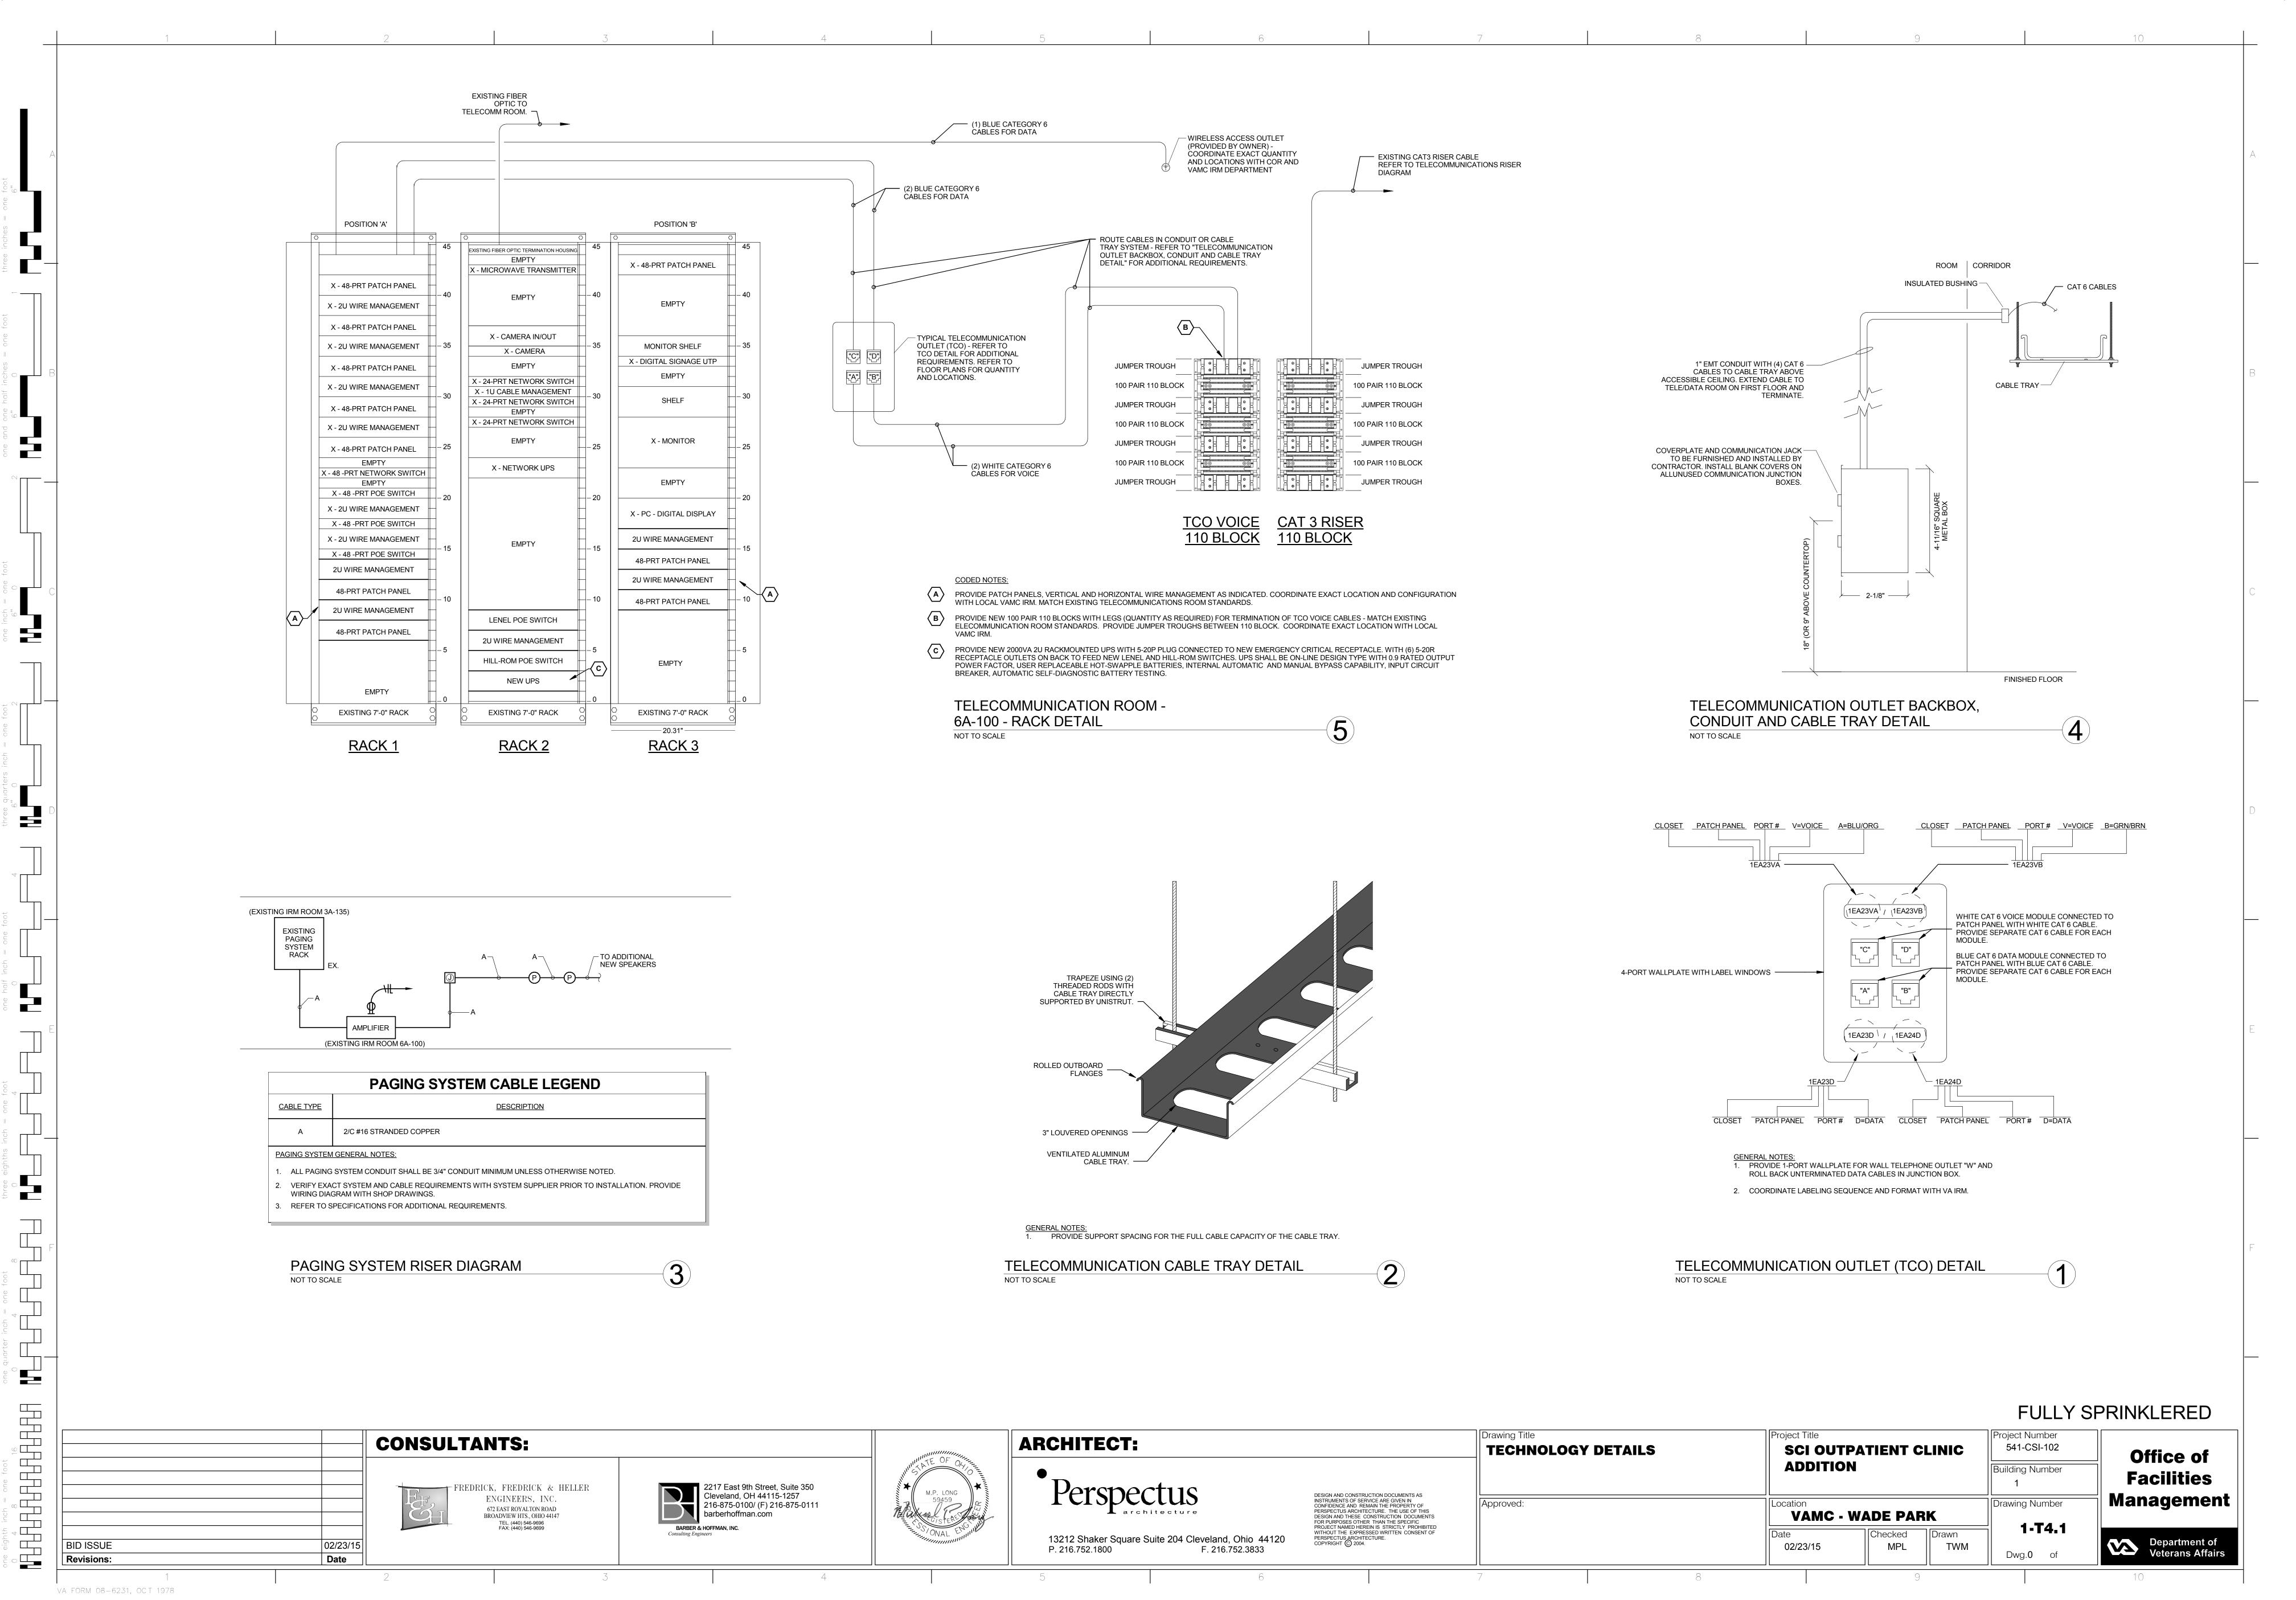

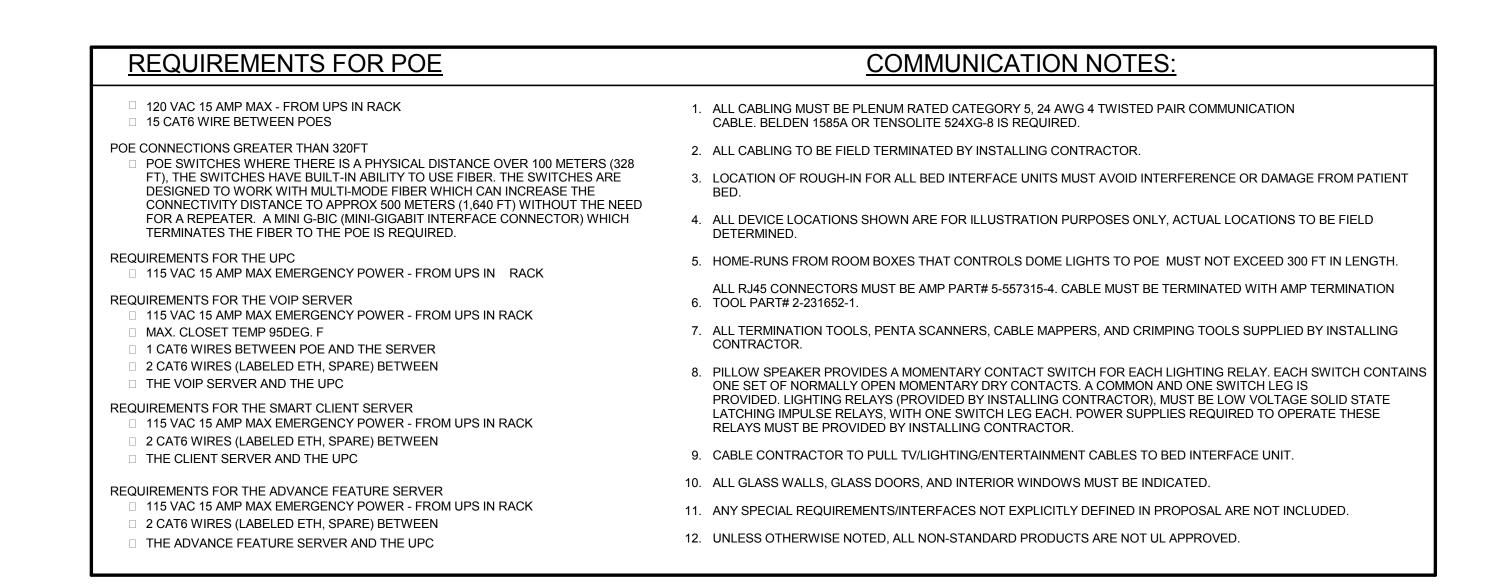

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## N1. NURSE CALL DEVICE, BACKBOX, CONDUIT, AND PULLWIRE SHALL BE FURNISHED, PROVIDED <u>BY CONTRACTOR</u>. CONTRACTOR SHALL PROVIDE ALL LINE-VOLTAGE POWER AND CONDUCTOR REQUIREMENTS FOR A COMPLETE SYSTEM. RISER DIAGRAM AND CODED NOTES ARE SHOWN WITH DEVICES <u>FOR REFERENCE ONLY.</u> N2. ALL NURSE CALL SYSTEM DEVICES SHALL BE CONNECTED COMPLETE TO THE MAIN NURSE CALL SYSTEM SWITCH BY THE CONTRACTOR IN ACCORDANCE WITH ENGINEER APPROVED MANUFACTURER'S SHOP DRAWING WIRING DIAGRAMS AND DETAILS. CONTRACTOR SHALL RETAIN HILLROM TO PROVIDE SHOP DRAWINGS FOR OWNER USE. N3. ALL NURSE CALL SYSTEM CONDUCTORS SHALL BE INSTALLED IN 3/4" MINIMUM SIZE CONDUIT STUBBED TO ABOVE FINISHED CEILING TO CABLE TRAY, OR J-HOOKS. J-HOOKS SPACED AT 2'-0" ON CENTER ABOVE FINISHED CEILING. COORDINATE REQUIREMENTS WITH VA COR. N4. REFER TO SPECIFICATIONS FOR ADDITIONAL REQUIREMENTS. NURSE CALL SYSTEM RISER CODED NOTES: NURSE CALL POWER-OVER-ETHERNET SWITCH: NEW HILL-ROM NAVICARE SWITCH (HILL-ROM #P2519NNC1A24)

1. PROVIDE NEW NURSE CALL SYSTEM AND DEVICES IN PROJECT AREA. CONNECT NEW NURSE CALL HEAD-END EQUIPMENT TO EXISTING HILL-ROM SYSTEM IN THE

PROVIDE ALL ADDITIONAL HILL-ROM COMPONENTS, SOFTWARE, ETC NECESSARY TO EXTEND THE EXISTING CAMPUS HILL-ROM NURSE CALL SYSTEM AND SATISFY THE GENERAL SCOPE OF THIS PROJECT WHICH IS TO:

EXACT QUANTITY OF ROOM CONTROL BOARDS (RBCs) SHALL BE DETERMINED BY HILL-ROM SYSTEM VENDOR ON SITE-SPECIFIC SHOP DRAWINGS.

MAIN CAMPUS BUILDING VIA NETWORK CABLING. FIELD VERIFY EXACT ROUTING OF CONDUITS AND WIRING.

A. 19" RACK-MOUNTABLE

D. 360W FOR PoE.

B. (24) 10/100M SWITCHING PORTS


E. COMPATIBLE WITH HILL-ROM NAVICARE AUDIO/VISUAL NURSE CALL DEVICES.

SATISFY THE GENERAL SCOPE OF THIS PROJECT WHICH IS TO;

(2) EXISTING NURSE CALL VOICE-OVER-IP SERVER: COORDINATE REQUIREMENTS WITH HILL-ROM

C. (2) GIGABIT COMBO PORTS


GENERAL NURSE CALL SYSTEM NOTES:

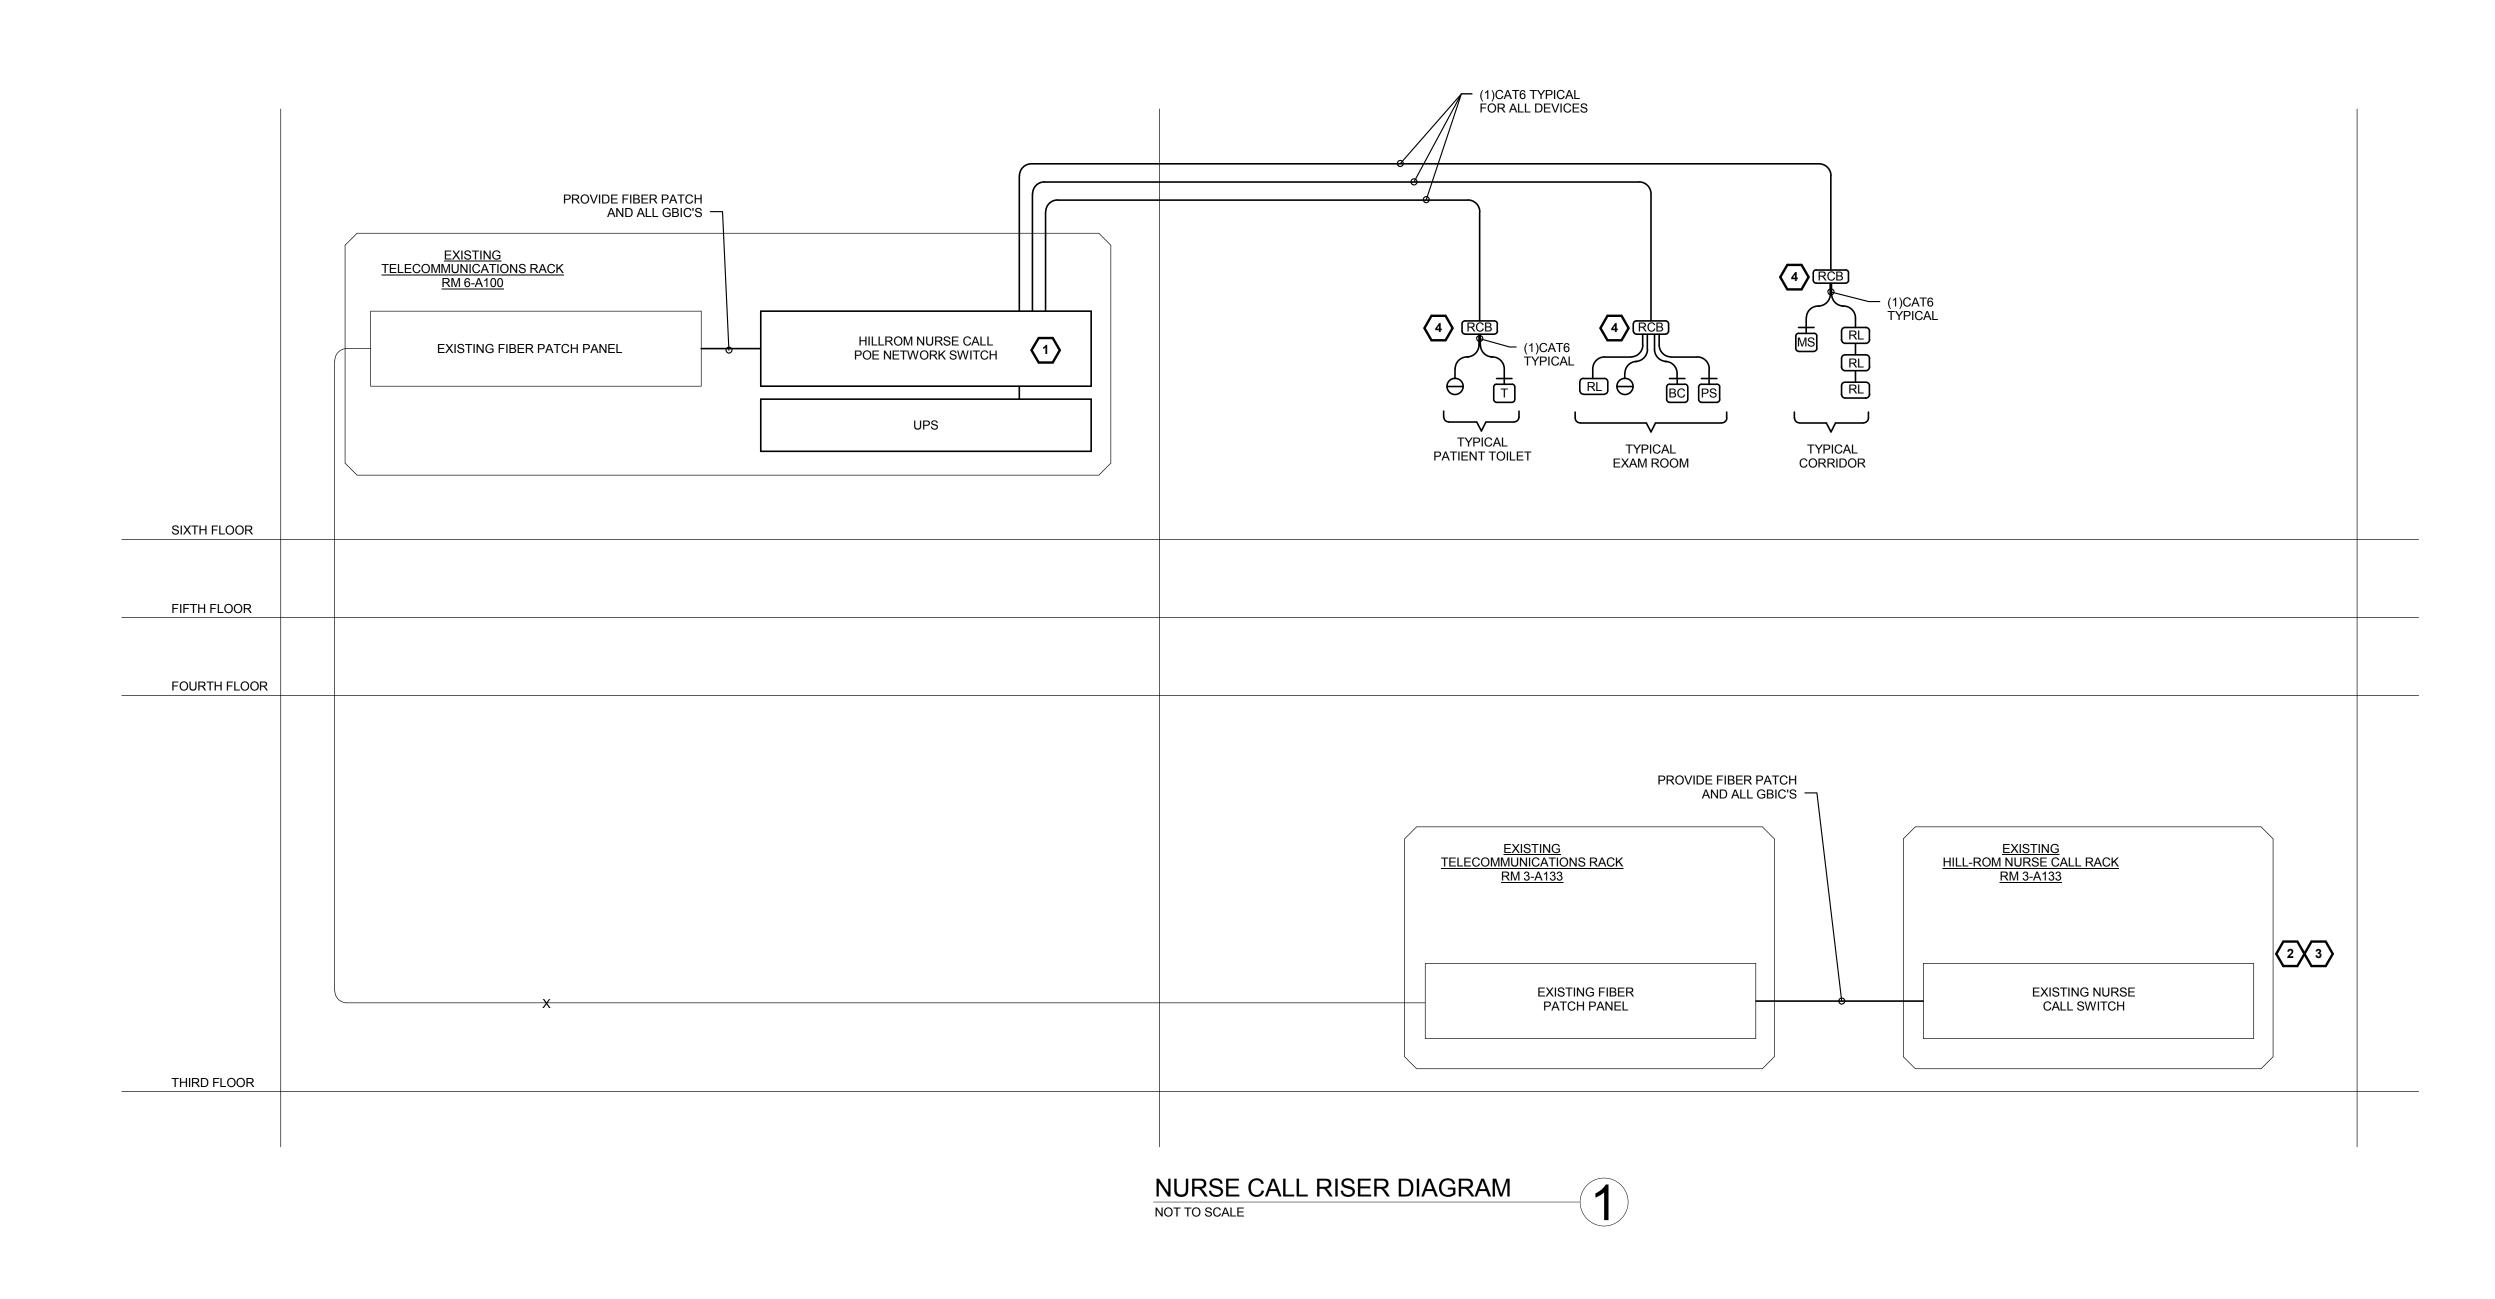


**FULLY SPRINKLERED** 

Project Title Project Number Drawing Title **CONSULTANTS: ARCHITECT:** 541-CSI-102 **SCI OUTPATIENT CLINIC NURSE CALL RISER DIAGRAM** Office of **ADDITION** Building Number **Facilities** 2217 East 9th Street, Suite 350 Cleveland, OH 44115-1257 FREDRICK, FREDRICK & HELLER DESIGN AND CONSTRUCTION DOCUMENTS AS INSTRUMENTS OF SERVICE ARE GIVEN IN CONFIDENCE AND REMAIN THE PROPERTY OF PERSPECTUS ARCHITECTURE. THE USE OF THIS DESIGN AND THESE CONSTRUCTION DOCUMENTS FOR PURPOSES OTHER THAN THE SPECIFIC PROJECT NAMED HEREIN IS STRICTLY PROHIBITED WITHOUT THE EXPRESSED WRITTEN CONSENT OF PERSPECTUS ARCHITECTURE. COPYRIGHT © 2004. Management ENGINEERS, INC. Drawing Number 216-875-0100/ (F) 216-875-0111 |Approved: 672 EAST ROYALTON ROAD **VAMC - WADE PARK** barberhoffman.com BROADVIEW HTS., OHIO 44147 TEL. (440) 546-9696 FAX: (440) 546-9699 1-T5.1 BARBER & HOFFMAN, INC. Drawn Checked 13212 Shaker Square Suite 204 Cleveland, Ohio 44120 Veterans Affairs BID ISSUE MPL TWM 02/23/15 P. 216.752.1800 F. 216.752.3833 Dwg.0 of Date Revisions:

FS,CT/ <u>19941-1,2,3</u> FT,MAST/ FS,CT,DW/ 19941-6,7,8,9 WP,WP,DW,CT/ Partial Fifth Floor Asbestos Abatement Plan 1

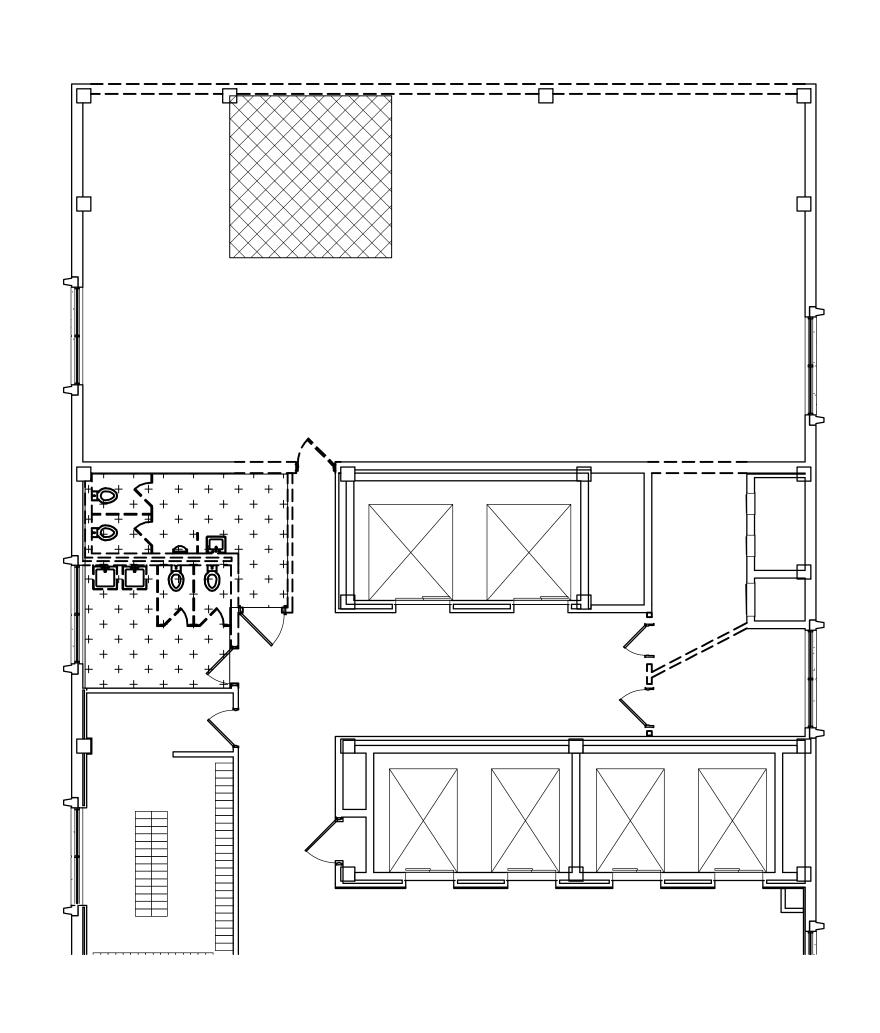

- (1) INSTALL CRITICAL BARRIERS AND WARNING SIGNS (SEE DETAIL SHEET 1-AA2)
- (2) INSTALL 6 MIL POLYETHYLENE DROP CLOTH BELOW PIPE INSULATION JOINTS TO AT LEAST 6 FEET HORIZONTAL DISTANCE FROM EACH ACM JOINT TO BE REMOVED
- (3) INSTALL NEGATIVE AIR MACHINE FOR LOCAL EXHAUST VENTILATION ADJACENT TO WORK AREA AND EXHAUST TO OUTSIDE OF BUILDING
- (4) FURNISH ALL LABOR, MATERIALS, EQUIPMENT AND SERVICES NECESSARY FOR THE REMOVAL AND DISPOSAL OF APPROXIMATELY 180 SQ FT OF ASBESTOS-CONTAINING INSULATION BELOW METAL JACKET ON BOILER STACK FROM THE 6TH FLOOR ROOF, 250 SQ FT OF ASBESTOS-CONTAINING MASTIC AND NON-ACM CERAMIC TILE FLOORING AND APPROXIMATELY 40 EACH PIPE INSULATION JOINTS FROM THE 6TH FLOOR RESTROOMS, 60 SQ FT OF ASBESTOS-CONTAINING MASTIC AND NON-ACM VINYL FLOOR TILES FROM THE 5TH FLOOR STAIRS, INCLUDING THE REMOVAL OF ALL NON-ACM CERAMIC TILE, VINYL FLOOR TILE, AND ANY DEMOLITION, REMOVAL, AND DISPOSAL NECESSARY TO EXPOSE ASBESTOS-CONTAINING MATERIALS AND THE REMOVAL OF MISCELLANEOUS ASBESTOS-CONTAINING MATERIALS AND DEBRIS INCLUDING ALL REQUIRED PREPARATION, CLEANING, ENCAPSULATION AND DECONTAMINATION IN ACCORDANCE WITH ALL REGULATORY AGENCY REQUIREMENTS AND THE PROJECT PLANS AND SPECIFICATIONS

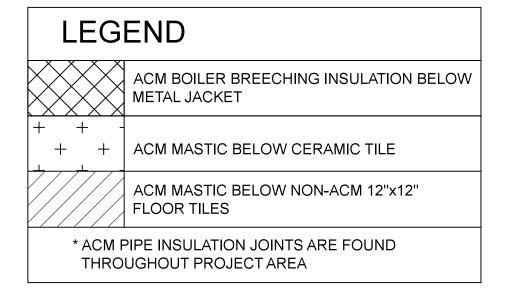


SAMPLE# TYPE/RESULTS

- FS FIRESTOPPING
- CT CEILING TILE
- DW DRYWALL
- WP WALL PLASTER FT - FLOOR TILE

# FINAL ISSUE **FULLY SPRINKLERED**

		CONSULTANTS:		
		Stephen J. Sebesta & Associates, Inc.		
		CONSULTING ENVIRONMENTAL HEALTH ENGINEERS		
Bid Issue	02/23/2015	17830 ENGLEWOOD DRIVE, SUITE 16, CLEVELAND, OHIO 44130 (216) 781-0060		

Date

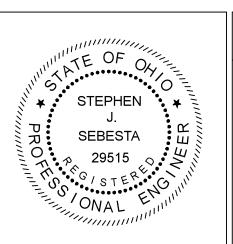

ARCHITECT:	Drawing Title
	PARTIAL SIXTH FLOOR ASBESTOS ABATEMENT PLAN
	Approved: Project Director

Partial Sixth Floor Asbestos Abatement Plan 1

0 4' 8' Scale 1/8" = 1'-0"

Project Title SCI OUTPATIENT CLINIC **ADDITION** 


Project Number 541-SCI-102 Office of Building Number **Facilities** Management Drawing Number

**1-AA1** Department of Veterans Affairs

**VAMC - WADE PARK** Drawn Checked 02/23/2015 CAJ **EMO** 

Dwg. 1 of 2

VA FORM 08-6231, OCT 1978

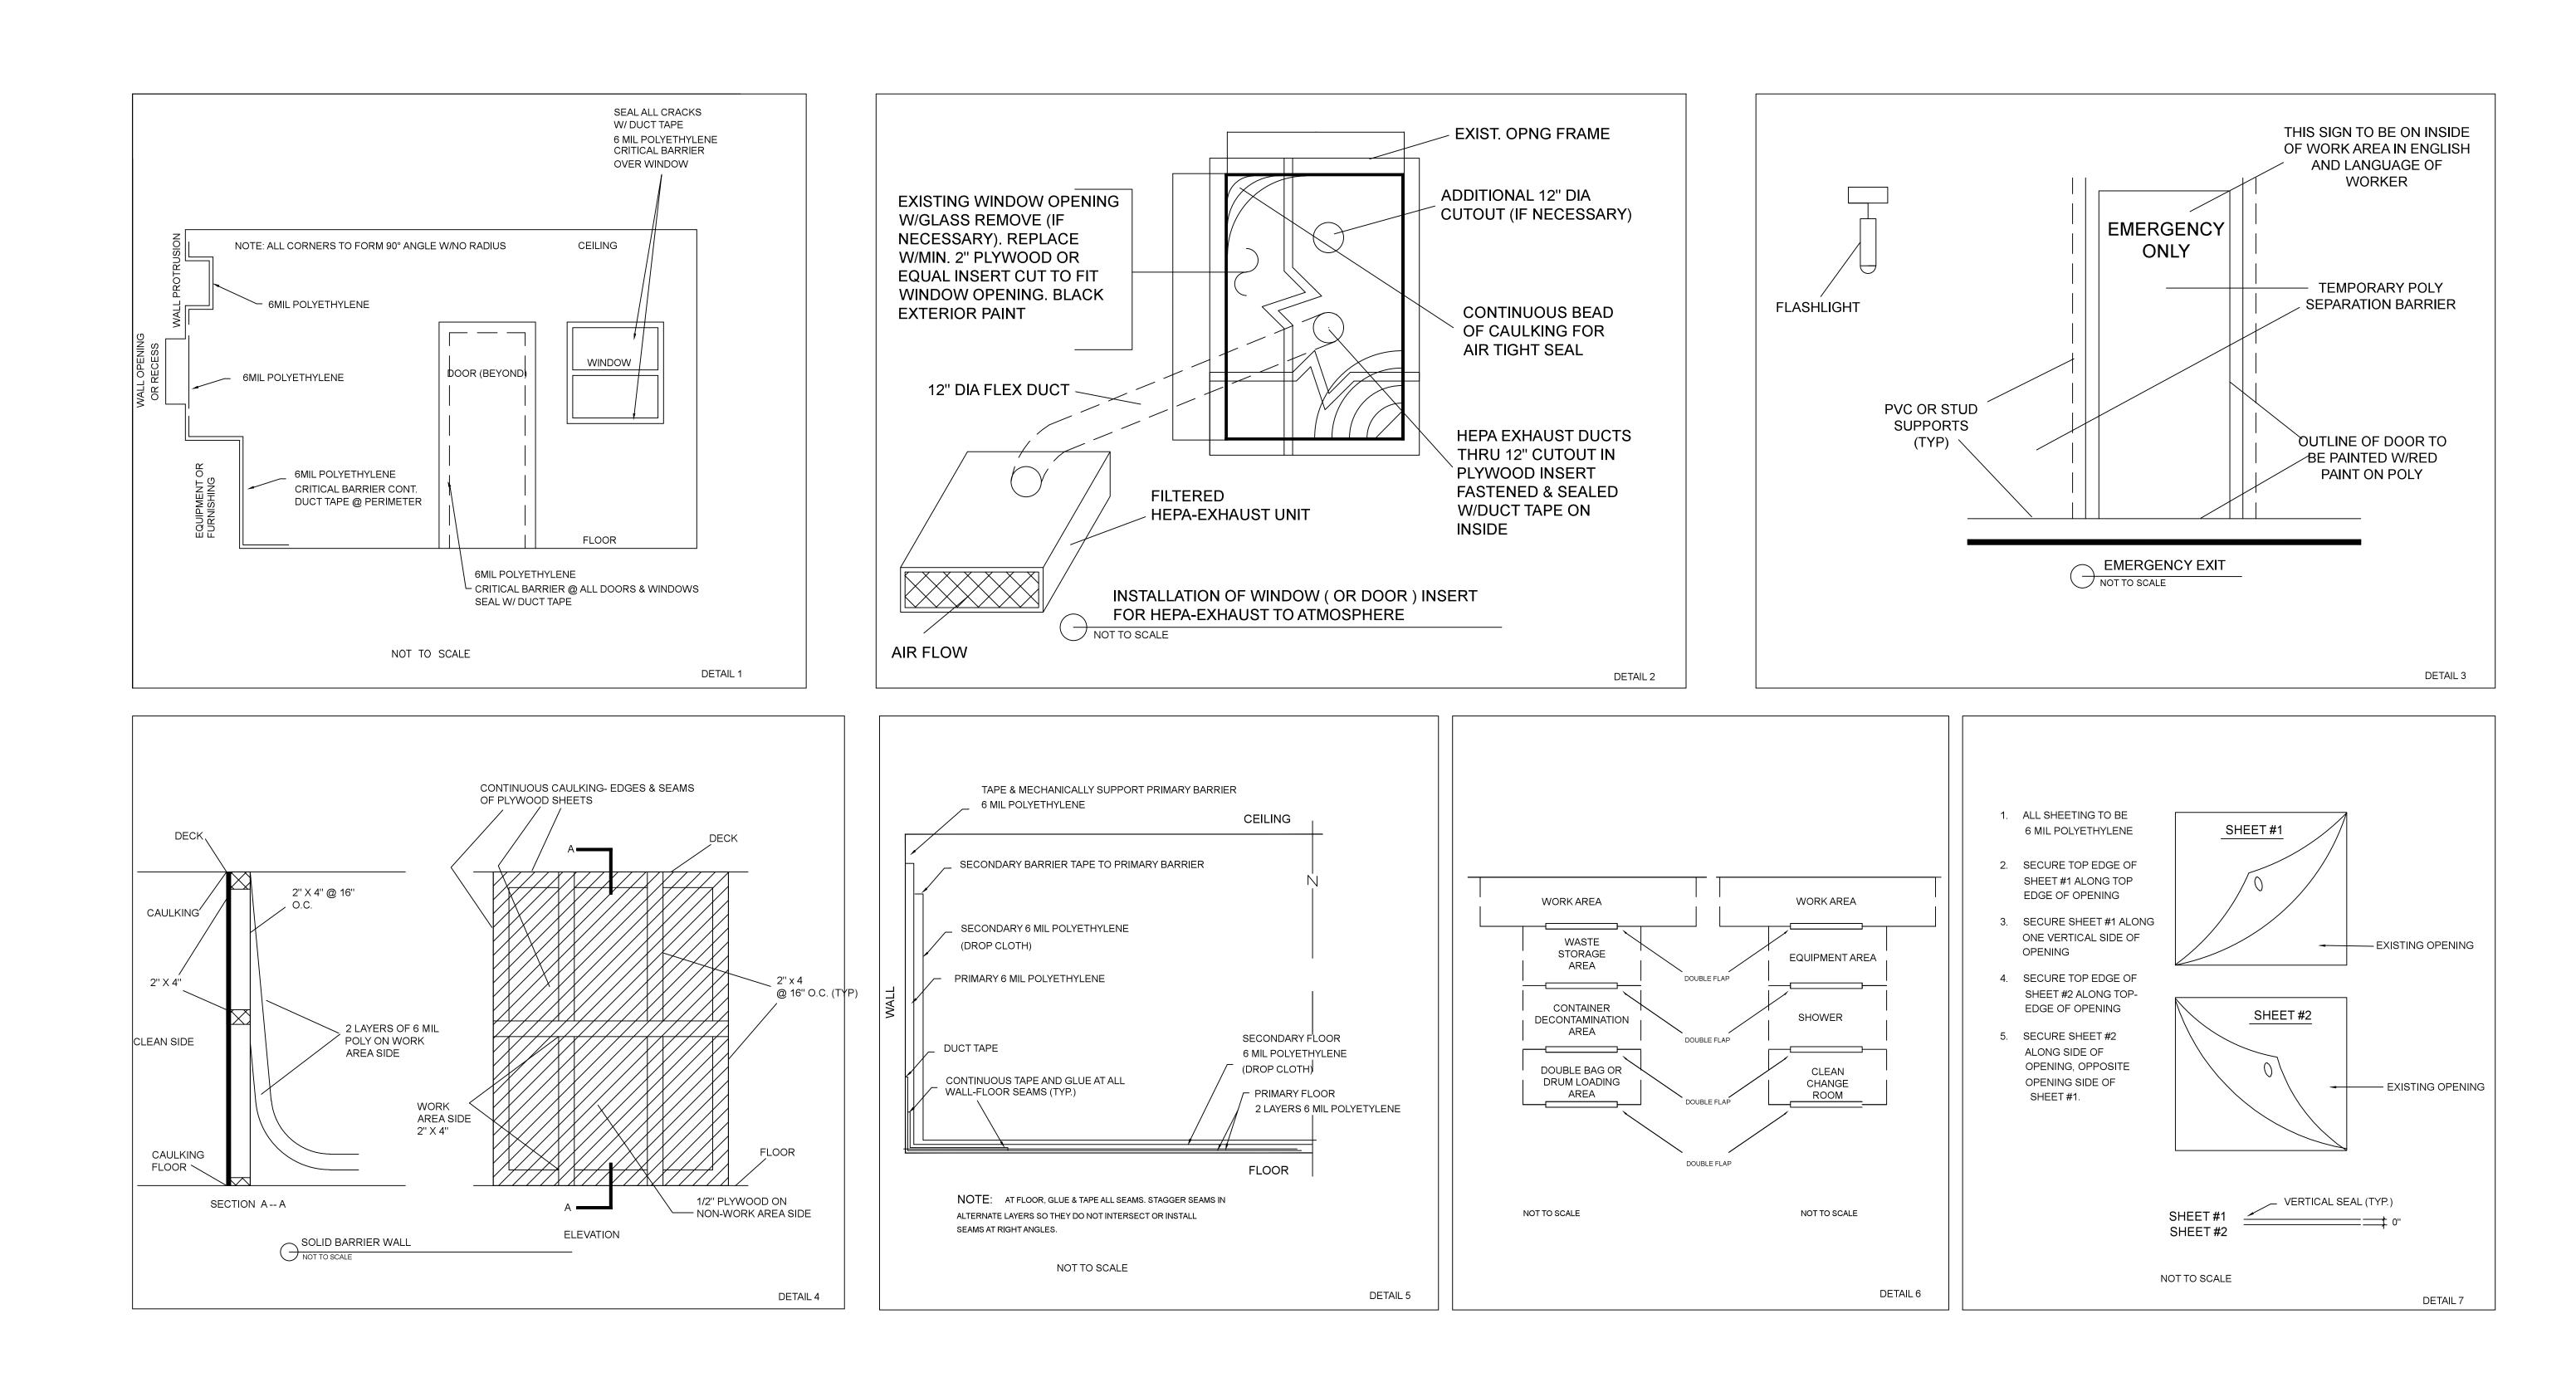

Standard Asbestos Abatement Details

# FINAL ISSUE FULLY SPRINKLERED

